

ASSESSORS MAP 610 BLOCK 58 LOTS 4 & 5  
477 & 479 BROADWAY  
METHUEN, MASSACHUSETTS


# PROPOSED DUNKIN' DONUTS SITE RE-DEVELOPMENT PLANS

for

## ASSESSORS MAP 610 BLOCK 58 LOTS 4 & 5 477 & 479 BROADWAY METHUEN, MASSACHUSETTS

Prepared for:


### CAFUA MANAGEMENT COMPANY, LLC 280 MERRIMACK STREET METHUEN, MA 01844

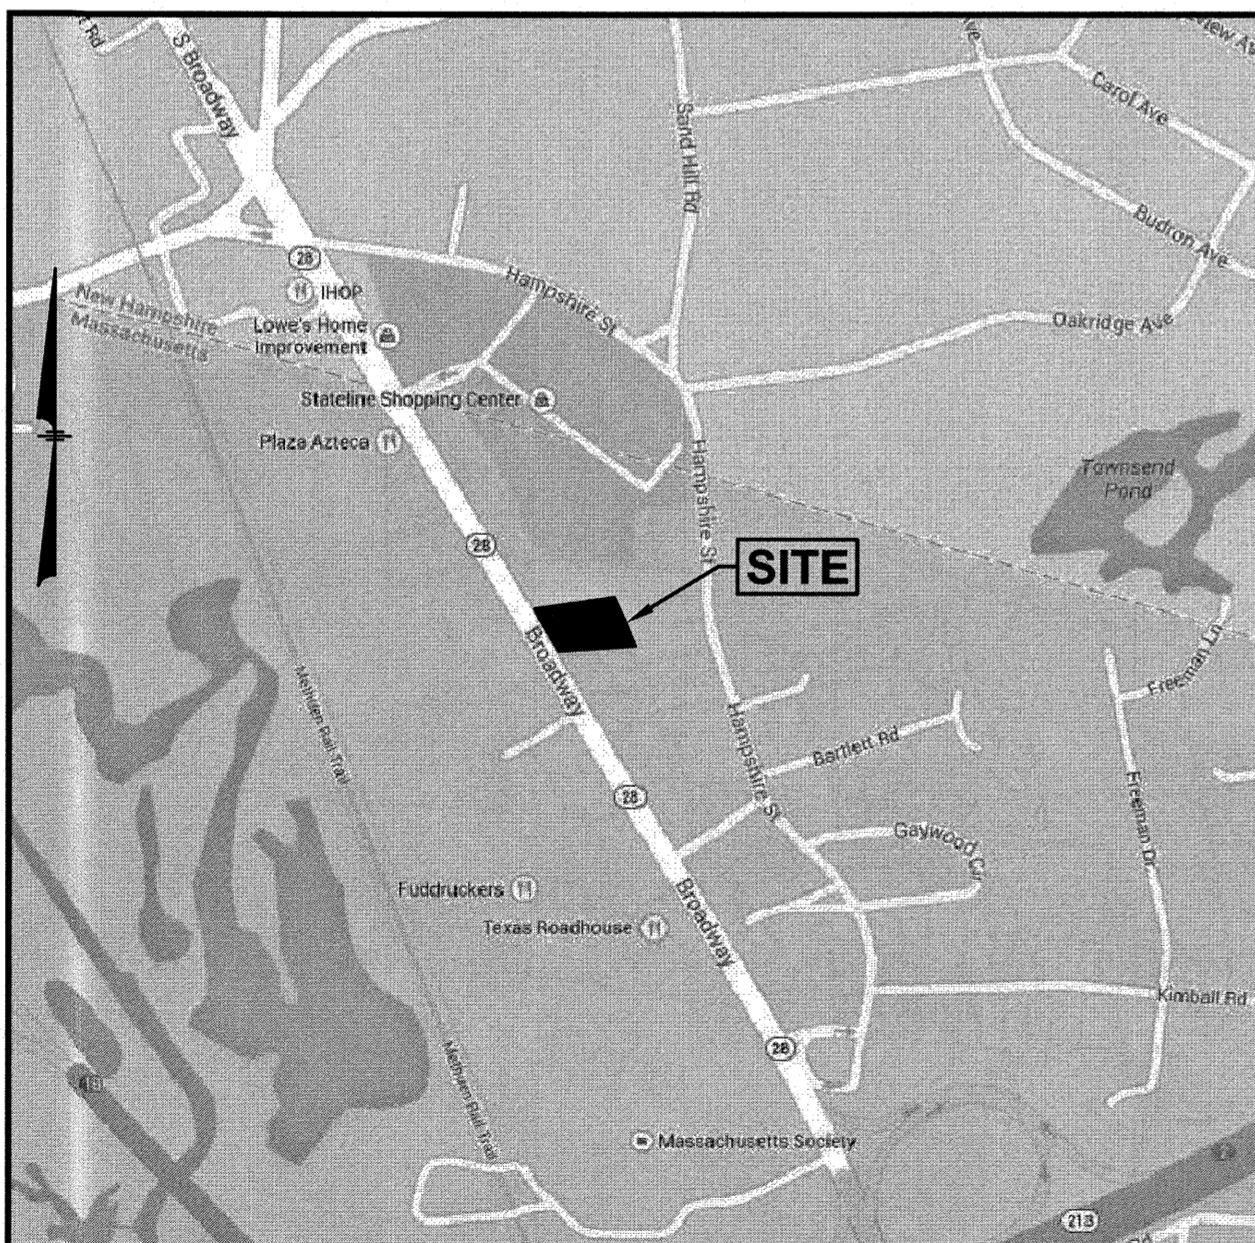

LOCATION MAP  
(NOT TO SCALE)

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- 1 OF 1. PROPOSED EXTERIOR ELEVATIONS (A4.1)

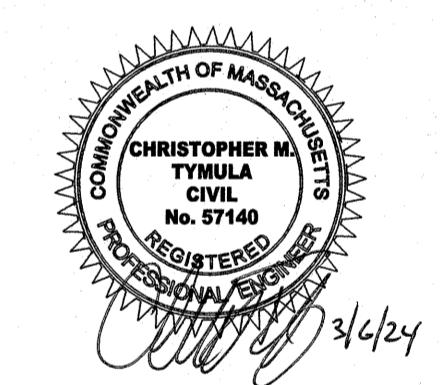

REVISIONS		
NO.	REVISION	DATE
		MARCH 6, 2024
DRAWN/DESIGN BY	CHECKED BY	
SJB/CMT	CMT	

TITLE SHEET	
SCALE:	AS NOTED
PROJECT NO.	NEX-2021347
1 OF 14	

LEGEND	
SGC	SLOPED GRANITE CURB
VGC	VERTICAL GRANITE CURB
SCC	SLOPED CONCRETE CURB
VCC	VERTICAL CONCRETE CURB
CCB	CAPE COD BERM
DSLY	DOUBLE SOLID LINE YELLOW
DDLY	DOUBLE DASHED LINE YELLOW
SDLY	SINGLE DASHED LINE YELLOW
SSLY	SINGLE SOLID LINE YELLOW
SSLW	SINGLE SOLID LINE WHITE
SDLW	SINGLE DASHED LINE WHITE
G	GAS LINE
T	UNDERGROUND TELEPHONE
W	WATER LINE
E	UNDERGROUND ELECTRIC
□	WOOD GUARDRAIL
○	METAL GUARDRAIL
○○	CHAIN LINK FENCE
○○○	STOCKADE FENCE
○○○○	POST & RAIL FENCE
—x—	WIRE FENCE
—90—	CONTOUR ELEVATION
○○	TREE
○○○	UTILITY POLE
—x—	GUY WIRE
—x—	OVERHEAD WIRE
—x—	TREELINE
—x—	PULL BOX
—x—	SIGN
○○○○	SPOT ELEVATION
○○○○	DRAIN MANHOLE
○○○○	CATCH BASIN
○○○○	ROOF DRAIN
○○○○	CLEANOUT
○○○○	VENT
○○○○	SEWER MANHOLE
○○○○	TELEPHONE MANHOLE
○○○○	ELECTRIC MANHOLE
○○○○	WATER MANHOLE
○○○○	MANHOLE
○○○○	GAS VALVE
○○○○	GAS SHUT OFF
○○○○	WATER VALVE
○○○○	WATER SHUT OFF
○○○○	FIRE HYDRANT
○○○○	BOLLARD
○○○○	GAS METER
○○○○	ELECTRIC METER
○○○○	MONITORING WELL
○○○○	LIGHT POLE
○○○○	BORING
—x—	WETLAND LINE
—x—	WATER FEATURE
—x—	UNDERGROUND COMM
—x—	DITCH LINE
—x—	EASEMENT LINE
—x—	PROPERTY LINE
—x—	ABUTTER PROPERTY LINE
—x—	BUILDING SETBACK
—x—	SOI TYPE LINE
—x—	ZONE LINE
—x—	FLOOD ZONE LINE
TBR	TO BE REMOVED
—x—	TO BE REMOVED
○	NUMBER OF PARKING SPACES
T.D.	TIP DOWN CURB
—x—	PROP. BIT. CONCRETE CURB (BCC)
—x—	PROP. VERTICAL GRANITE CURB (VGC)
—x—	PROP. XXXX CURB (XXX)
—x—	PROP. XXXX CURB (XXX)
C.O.	PROP. CLEANOUT
CB-1	PROP. CATCH BASIN
DMH-1	PROP. DRAIN MANHOLE
MEG	MEET EXISTING GRADE
331.25	PROP. SPOT ELEVATION
300	PROP. CONTOUR ELEVATION
TW=	TOP OF WALL ELEV.
BW=	BOTTOM OF WALL ELEV.
G.B.	GRADE BREAK
TP	TEST PIT
—x—	PROP. GATE VALVE
—x—	PROP. SEDIMENT CONTROL FENCE

**GENERAL NOTES:**

- ZONE: HIGHWAY BUSINESS (BH)
- SETBACKS: FRONT: 25'  
SIDE: 30'  
REAR: 30'  
\* ADDITIONAL BUFFER ZONE OF 30' IS ADDED TO SETBACK AREA WHEN ADJACENT TO RESIDENTIAL
- LOT AREA = 43,119 SF (COMBINED LOTS 4 & 5)
- EXISTING USE: FORMERLY TWO 2-STORY RESIDENTIAL HOMES WITH DETACHED GARAGES.  
PROPOSED USE: 2,100 SF DONUT SHOP WITH DRIVE THRU.
- ALL BUILDINGS AND SITE CONSTRUCTION SHALL COMPLY WITH THE RULES AND REGULATIONS OF THE AMERICANS WITH DISABILITIES ACT (ADA) AS REVISIED IN 2010, OR LATEST REVISION.
- THE LOCATIONS OF EXISTING SUBSURFACE UTILITIES SHOWN ON THIS PLAN WERE COMPILED FROM AVAILABLE RECORD DRAWINGS AND ARE NOT WARRANTED TO BE CORRECT. THE CONTRACTOR SHALL VERIFY THE LOCATION OF ALL EXISTING SUBSURFACE UTILITIES PRIOR TO PERFORMING ANY WORK.
- WRITTEN DIMENSIONS ON THIS PLAN TAKE PRECEDENCE OVER SCALED DIMENSIONS. THE CONTRACTOR SHALL USE CAUTION WHEN SCALING REPRODUCED PLANS. IN THE EVENT OF A CONFLICT BETWEEN THIS PLAN SET AND ANY OTHER DRAWINGS AND/OR SPECIFICATIONS, THE ENGINEER SHALL BE NOTIFIED BY THE CONTRACTOR.
- THE CONTRACTOR SHALL CALL AND COORDINATE WITH DIGSAFE 1-888-344-7233 PRIOR TO ANY EXCAVATION.
- ALL CONSTRUCTION SHALL CONFORM TO THE APPLICABLE REGULATIONS AND STANDARDS OF THE CITY OF METHUEN AND THE COMMONWEALTH OF MASSACHUSETTS.
- THE SITE IS NOT WITHIN THE 100 YEAR FLOOD BOUNDARY HAZARD ZONE. (SEE SHEET 3 OF 14, NOTE 6)
- ALL UTILITIES TO BE TAKEN OUT OF SERVICE SHALL BE DISCONNECTED AS DIRECTED BY UTILITY COMPANY AND LOCAL DPW.
- ALL CONSTRUCTION SHALL CONFORM TO THESE PLANS AND THE STANDARD CONSTRUCTION DRAWINGS AS SUPPLIED BY THE DEVELOPER.
- THE CONTRACTOR IS SOLELY RESPONSIBLE FOR THE MEANS AND METHODS OF CONSTRUCTION AND FOR COMPLIANCE AT THE SITE. PLANS PREPARED BY GREENMAN-PEDERSEN, INC. DO NOT EXTEND TO OR INCLUDE SYSTEMS PERTAINING TO THE SAFETY OF THE CONSTRUCTION CONTRACTOR OR THEIR EMPLOYEES, AGENTS OR REPRESENTATIVES IN THE PERFORMANCE OF THE WORK. THE SEAL OF THE SURVEYOR AND/OR ENGINEER AS INCLUDED IN THE PLAN SET DOES NOT EXTEND TO ANY SUCH SAFETY SYSTEMS THAT MAY NOW OR HEREAFTER BE INCORPORATED INTO THESE PLANS. THE CONSTRUCTION CONTRACTOR SHALL PREPARE AND/OR OBTAIN THE APPROPRIATE SAFETY SYSTEMS WHICH MAY BE REQUIRED BY THE U.S. OCCUPATIONAL SAFETY AND HEALTH ADMINISTRATION (OSHA) AND/OR LOCAL REGULATIONS.
- ALL SNOW SHALL BE STORED IN THE AREA(S) DEPICTED ON THIS PLAN AS SNOW STORAGE AREAS. IN THE EVENT THAT THE AREA(S) APPROVED FOR SNOW STORAGE BECOME FULL, THE OWNER SHALL REASONABLY REMOVE EXCESS SNOW FROM THE SITE, AND SHALL NOT ALLOW SNOW TO BE STORED WITHIN PARKING LOTS OR TRAVEL AISLES.
- REFER TO DETAIL SHEETS FOR ALL SITE DEVELOPMENT DETAILS AND INFORMATION.
- A SIGN PERMIT SHALL BE OBTAINED PRIOR TO INSTALLATION.
- EXISTING IMPERVIOUS COVERAGE = 8,655 SF (20%)  
PROPOSED IMPERVIOUS COVERAGE = 21,433 SF (50%)

**DEMOLITION:**

- A DEMOLITION PERMIT MUST BE OBTAINED FROM THE CITY OF METHUEN PRIOR TO COMMENCEMENT OF WORK. ALL EXISTING UTILITY DISCONNECTIONS MUST BE COORDINATED WITH RESPECTIVE UTILITY COMPANIES.
- ALL DEMOLITION ACTIVITIES ARE TO BE PERFORMED IN STRICT ADHERENCE TO ALL FEDERAL, STATE AND LOCAL REGULATIONS. CONTRACTOR TO INSTALL EROSION CONTROL DEVICES IN ACCORDANCE WITH EROSION AND SEDIMENT CONTROL PLAN PRIOR TO BEGINNING DEMOLITION ACTIVITIES.
- PROCEED WITH DEMOLITION IN A SYSTEMATIC MANNER, FROM THE TOP OF THE STRUCTURE(S) TO THE GROUND.
- DEMOLISH CONCRETE IN ALL SECTIONS.
- BREAK UP CONCRETE SLABS—ON-GRADE, UNLESS OTHERWISE DIRECTED BY THE CONSTRUCTION MANAGER.
- CONDUCT ALL DEMOLITION OPERATIONS IN A MANNER THAT WILL PREVENT INJURY, DAMAGE TO STRUCTURES, ADJACENT BUILDINGS AND ALL PERSONS.
- REFRAIN FROM USING EXPLOSIVES WITHOUT PRIOR WRITTEN CONSENT OF THE DEVELOPER AND APPLICABLE GOVERNMENTAL AUTHORITIES.
- CONDUCT DEMOLITION SERVICES IN SUCH A MANNER TO ENSURE MINIMUM INTERFERENCE WITH ROADS, STREETS, WALKS AND OTHER ADJACENT FACILITIES. DO NOT CLOSE OR OBSTRUCT STREETS, WALKS OR OTHER OCCUPIED FACILITIES WITHOUT PRIOR WRITTEN PERMISSION OF THE DEVELOPER AND APPLICABLE GOVERNMENTAL AUTHORITIES. PROVIDE ALTERNATIVE ROUTES AROUND CLOSED OR OBSTRUCTED TRAFFIC WAYS IF REQUIRED BY APPLICABLE GOVERNMENTAL REGULATIONS.
- USE WATERING, TEMPORARY ENCLOSURES AND OTHER SUITABLE METHODS, AS NECESSARY TO LIMIT THE AMOUNT OF DUST AND DIRT RISING AND SCATTERING IN THE AIR. CLEAN ADJACENT STRUCTURE AND IMPROVEMENTS OF ALL DUST AND DEBRIS CAUSED BY THE DEMOLITION OPERATIONS. RETURN ALL ADJACENT AREAS TO THE CONDITIONS EXISTING PRIOR TO THE START OF WORK.
- ACCOMPLISH AND PERFORM THE DEMOLITION IN SUCH A MANNER AS TO PREVENT THE UNAUTHORIZED ENTRY OF PERSONS AT ANY TIME.
- COMPLETELY FILL BELOW GRADE AREAS AND VOIDS RESULTING FROM THE DEMOLITION OF STRUCTURES AND FOUNDATIONS WITH SOIL MATERIALS CONSISTING OF STONE, GRAVEL AND SAND, FREE FROM DEBRIS, TRASH, FROZEN MATERIALS, ROOTS AND OTHER ORGANIC MATTER. STONES USED WILL NOT BE LARGER THAN 6 INCHES IN DIMENSION. MATERIAL FROM DEMOLITION MAY NOT BE USED AS FILL PRIOR TO PLACEMENT OF FILL MATERIALS UNDERTAKE ALL NECESSARY ACTIVITIES PRIOR TO THE PLACEMENT OF FILL MATERIALS. PLACE FILL MATERIALS LAYERS NOT EXCEEDING 6 INCHES IN LOOSE DEPTH AND COMPACT EACH LAYER AT PLACEMENT TO 95% OPTIMUM DENSITY, GRADE SURFACE TO MEET ADJACENT CONTOURS AND TO PROVIDE SURFACE DRAINAGE.
- REMOVE FROM THE DESIGNATED SITE, AT THE EARLIEST POSSIBLE TIME, ALL DEBRIS, RUBBISH, SALVAGEABLE ITEMS, HAZARDOUS AND COMBUSTIBLE MATERIALS, REMOVED MATERIALS THAT NOT BE STORED, SOLD OR BURNED ON SITE. REMOVAL OF HAZARDOUS AND COMBUSTIBLE MATERIALS SHALL BE ACCOMPLISHED IN ACCORDANCE WITH THE PROCEDURES AS AUTHORIZED BY THE FIRE DEPARTMENT OR OTHER APPROPRIATE REGULATORY AGENCIES AND DEPARTMENTS.
- DISCONNECT, SHUT OFF AND SEAL ALL UTILITIES SERVING THE STRUCTURE(S) TO BE DEMOLISHED BEFORE THE COMMENCEMENT OF THE DESIGNATED DEMOLITION. MARK FOR POSITION ALL UTILITY DRAINAGE AND SANITARY LINES AND PROTECT ALL ACTIVE LINES, CLEARLY IDENTIFY BEFORE THE COMMENCEMENT OF DEMOLITION SERVICES THE REQUIRED INTERRUPTION OF ACTIVE SYSTEMS THAT MAY AFFECT OTHER PARTIES, AND NOTIFY ALL APPLICABLE UTILITY COMPANIES TO INSURE THE CONTINUATION OF SERVICE.
- PROTECT EXISTING DRAINAGE SYSTEM(S) AS NECESSARY TO PREVENT SEDIMENT FROM ENTERING DURING CONSTRUCTION. SEE DETAIL SHEETS FOR EROSION CONTROL DEVICES.
- ALL WORK WITHIN ROADWAY RIGHT-OF-WAYS TO CONFORM TO CITY STANDARDS.
- THE LIMITS OF WORK SHALL BE CLEARLY MARKED IN THE FIELD PRIOR TO THE START OF CONSTRUCTION OR SITE CLEARING.
- IT SHALL BE THE CONTRACTOR'S RESPONSIBILITY TO NOTIFY DIG SAFE (DIAL 811) 72 HOURS PRIOR TO ANY EXCAVATION ON THIS SITE. CONTRACTOR SHALL ALSO NOTIFY LOCAL WATER DEPARTMENT TO MARK OUT THEIR UTILITIES.
- NOTES ON THIS PLAN THAT READ "TBR" REPRESENT FEATURES TO BE REMOVED. ANY FEATURES NOT LABELED "TBR" OR "TO BE REMOVED" SHALL BE CONSIDERED EXISTING TO REMAIN.
- SEE LANDSCAPE PLAN FOR LIMITS OF CLEARING AND GRUBBING. AFTER CLEARING, STRIP AND STOCKPILE TOP SOIL PER LANDSCAPE PLAN, IF APPLICABLE.

**GRADING & DRAINAGE:**

- ALL SITE DRAINAGE PIPE SHALL BE CORRUGATED HIGH-DENSITY POLYETHYLENE PIPE WITH STANDARD JOINTS, DUAL-WALL, SMOOTH INTERIOR, AS MANUFACTURED BY ADS, INC., OR APPROVED EQUAL, UNLESS OTHERWISE NOTED ON PLAN. THE UNDERGROUND DETENTION SYSTEM SHALL HAVE SOIL TIGHT (ST) JOINTS MEETING ASTM F477 SPECIFICATIONS.
- ALL ROOF AND CANOPY DRAIN PIPE SHALL BE 6" PVC (SDR-35), EXCEPT WITHIN 10' OF A BUILDING FOUNDATION WHERE CAST IRON PIPE SHALL BE USED. MIN. SLOPE=2%.
- ELEVATIONS ARE BASED ON NAVD88 DATUM.
- ALL PROPOSED ELEVATIONS AS SHOWN ARE BOTTOM OF CURB ELEVATIONS, UNLESS OTHERWISE NOTED.
- ANY UTILITY FIELD ADJUSTMENTS SHALL BE APPROVED BY THE ENGINEER OF RECORD AND COORDINATED WITH THE APPROPRIATE LOCAL UTILITY COMPANY.
- THE LOCATIONS OF UNDERGROUND UTILITIES ARE APPROXIMATE ONLY. THE CONTRACTOR IS TO VERIFY EXACT LOCATION PRIOR TO CONSTRUCTION. THE CONTRACTOR IS TO NOTIFY THE DESIGN ENGINEER OF ANY DISCREPANCIES. CONSTRUCTION SHALL COMMENCE BEGINNING AT THE LOWEST INVERT (POINT OF CONNECTION) AND PROGRESS UP GRADIENT. PROPOSED INTERFACE POINTS (CROSSINGS) WITH EXISTING UNDERGROUND INSTALLATIONS SHALL BE FIELD VERIFIED BY TEST PIT PRIOR TO COMMENCEMENT OF CONSTRUCTION.
- ALL CONSTRUCTION SHALL CONFORM TO MUNICIPAL DPW AND ALL APPLICABLE STATE AND FEDERAL STANDARDS.
- THE CONTRACTOR SHALL CALL AND COORDINATE WITH DIG-SAFE 811 PRIOR TO COMMENCING ANY EXCAVATION.
- ALL CONSTRUCTION SHALL CONFORM TO THE APPLICABLE REGULATIONS AND STANDARDS OF THE CITY OF METHUEN AND THE COMMONWEALTH OF MASSACHUSETTS.
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**UTILITIES:**

- ALL SANITARY SEWER PIPE SHALL BE PVC (SDR-35), UNLESS OTHERWISE NOTED.
- ALL WATER PIPE SHALL BE COPPER (TYPE K), UNLESS OTHERWISE NOTED.
- ANY UTILITY FIELD ADJUSTMENTS SHALL BE APPROVED BY THE ENGINEER OF RECORD AND COORDINATED WITH THE APPROPRIATE LOCAL UTILITY COMPANY.
- THE LOCATIONS OF UNDERGROUND UTILITIES ARE APPROXIMATE ONLY. THE CONTRACTOR IS TO VERIFY EXACT LOCATION PRIOR TO CONSTRUCTION. THE CONTRACTOR IS TO NOTIFY THE DESIGN ENGINEER OF ANY DISCREPANCIES.
- ALL CONSTRUCTION SHALL CONFORM TO MUNICIPAL DPW AND ALL APPLICABLE STATE AND FEDERAL STANDARDS.
- THE CONTRACTOR SHALL CALL AND COORDINATE WITH DIGSAFE 811 PRIOR TO ANY EXCAVATION.
- ALL WATER AND SEWER CONSTRUCTION SHALL CONFORM TO DEPARTMENT OF PUBLIC WORKS SPECIFICATIONS.
- THIS SITE IS SERVED BY MUNICIPAL SEWER AND WATER.
- ALL ELECTRIC, TELEPHONE AND CABLE TV LINES ARE TO BE UNDERGROUND AND INSTALLED IN CONFORMANCE WITH APPLICABLE UTILITY CO. SPECIFICATIONS.
- ANY UTILITIES TO BE TAKEN OUT OF SERVICE SHALL BE DISCONNECTED AS DIRECTED BY UTILITY COMPANY AND LOCAL DPW.
- ALL TRAFFIC CONTROL AND TEMPORARY CONSTRUCTION SIGNAGE ARRANGEMENTS, ACCEPTABLE TO MASSDOT AND CITY DEPARTMENT OF PUBLIC WORKS, SHALL BE EMPLOYED DURING OPERATIONS WITHIN THE PUBLIC RIGHT-OF-WAY.
- REFRAIN FROM USING EXPLOSIVES WITHOUT PRIOR WRITTEN CONSENT OF THE DEVELOPER AND APPLICABLE GOVERNMENTAL AUTHORITIES.
- CONDUCT DEMOLITION SERVICES IN SUCH A MANNER TO ENSURE MINIMUM INTERFERENCE WITH ROADS, STREETS, WALKS AND OTHER ADJACENT FACILITIES. DO NOT CLOSE OR OBSTRUCT STREETS, WALKS OR OTHER OCCUPIED FACILITIES WITHOUT PRIOR WRITTEN PERMISSION OF THE DEVELOPER AND APPLICABLE GOVERNMENTAL AUTHORITIES. PROVIDE ALTERNATIVE ROUTES AROUND CLOSED OR OBSTRUCTED TRAFFIC WAYS IF REQUIRED BY APPLICABLE GOVERNMENTAL REGULATIONS.
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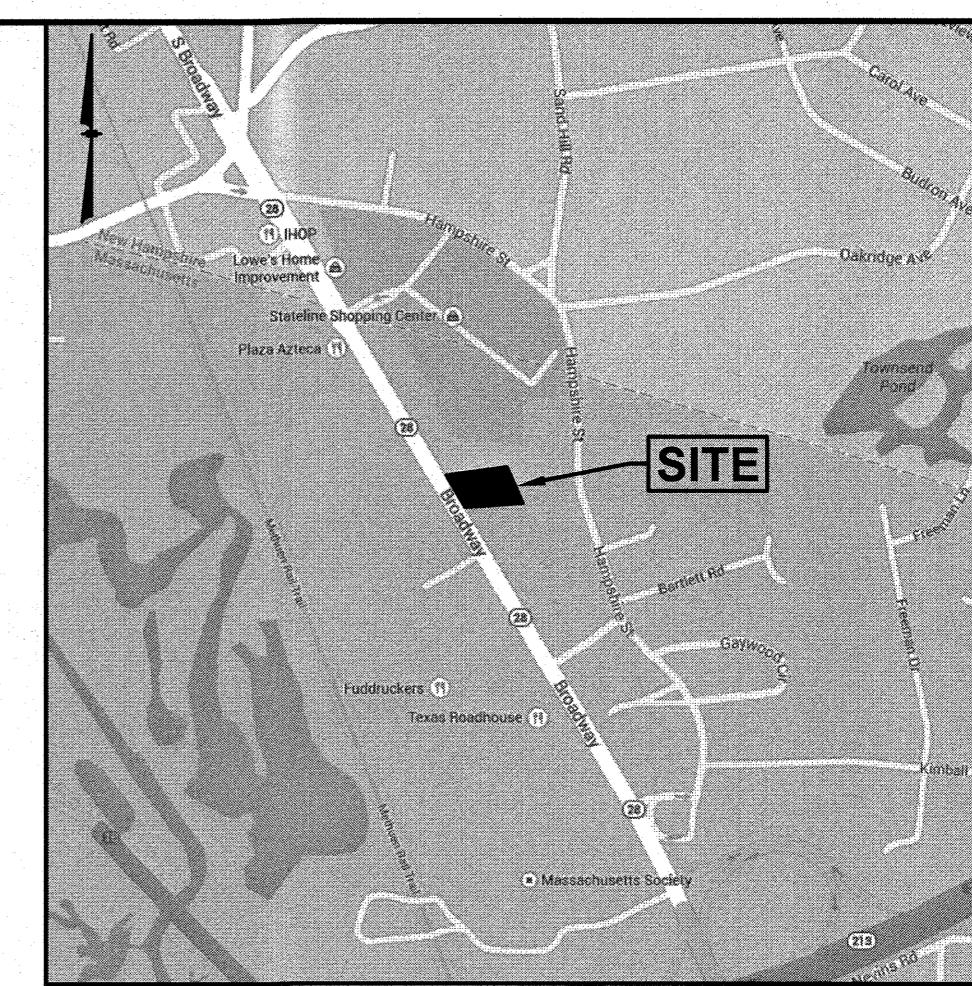
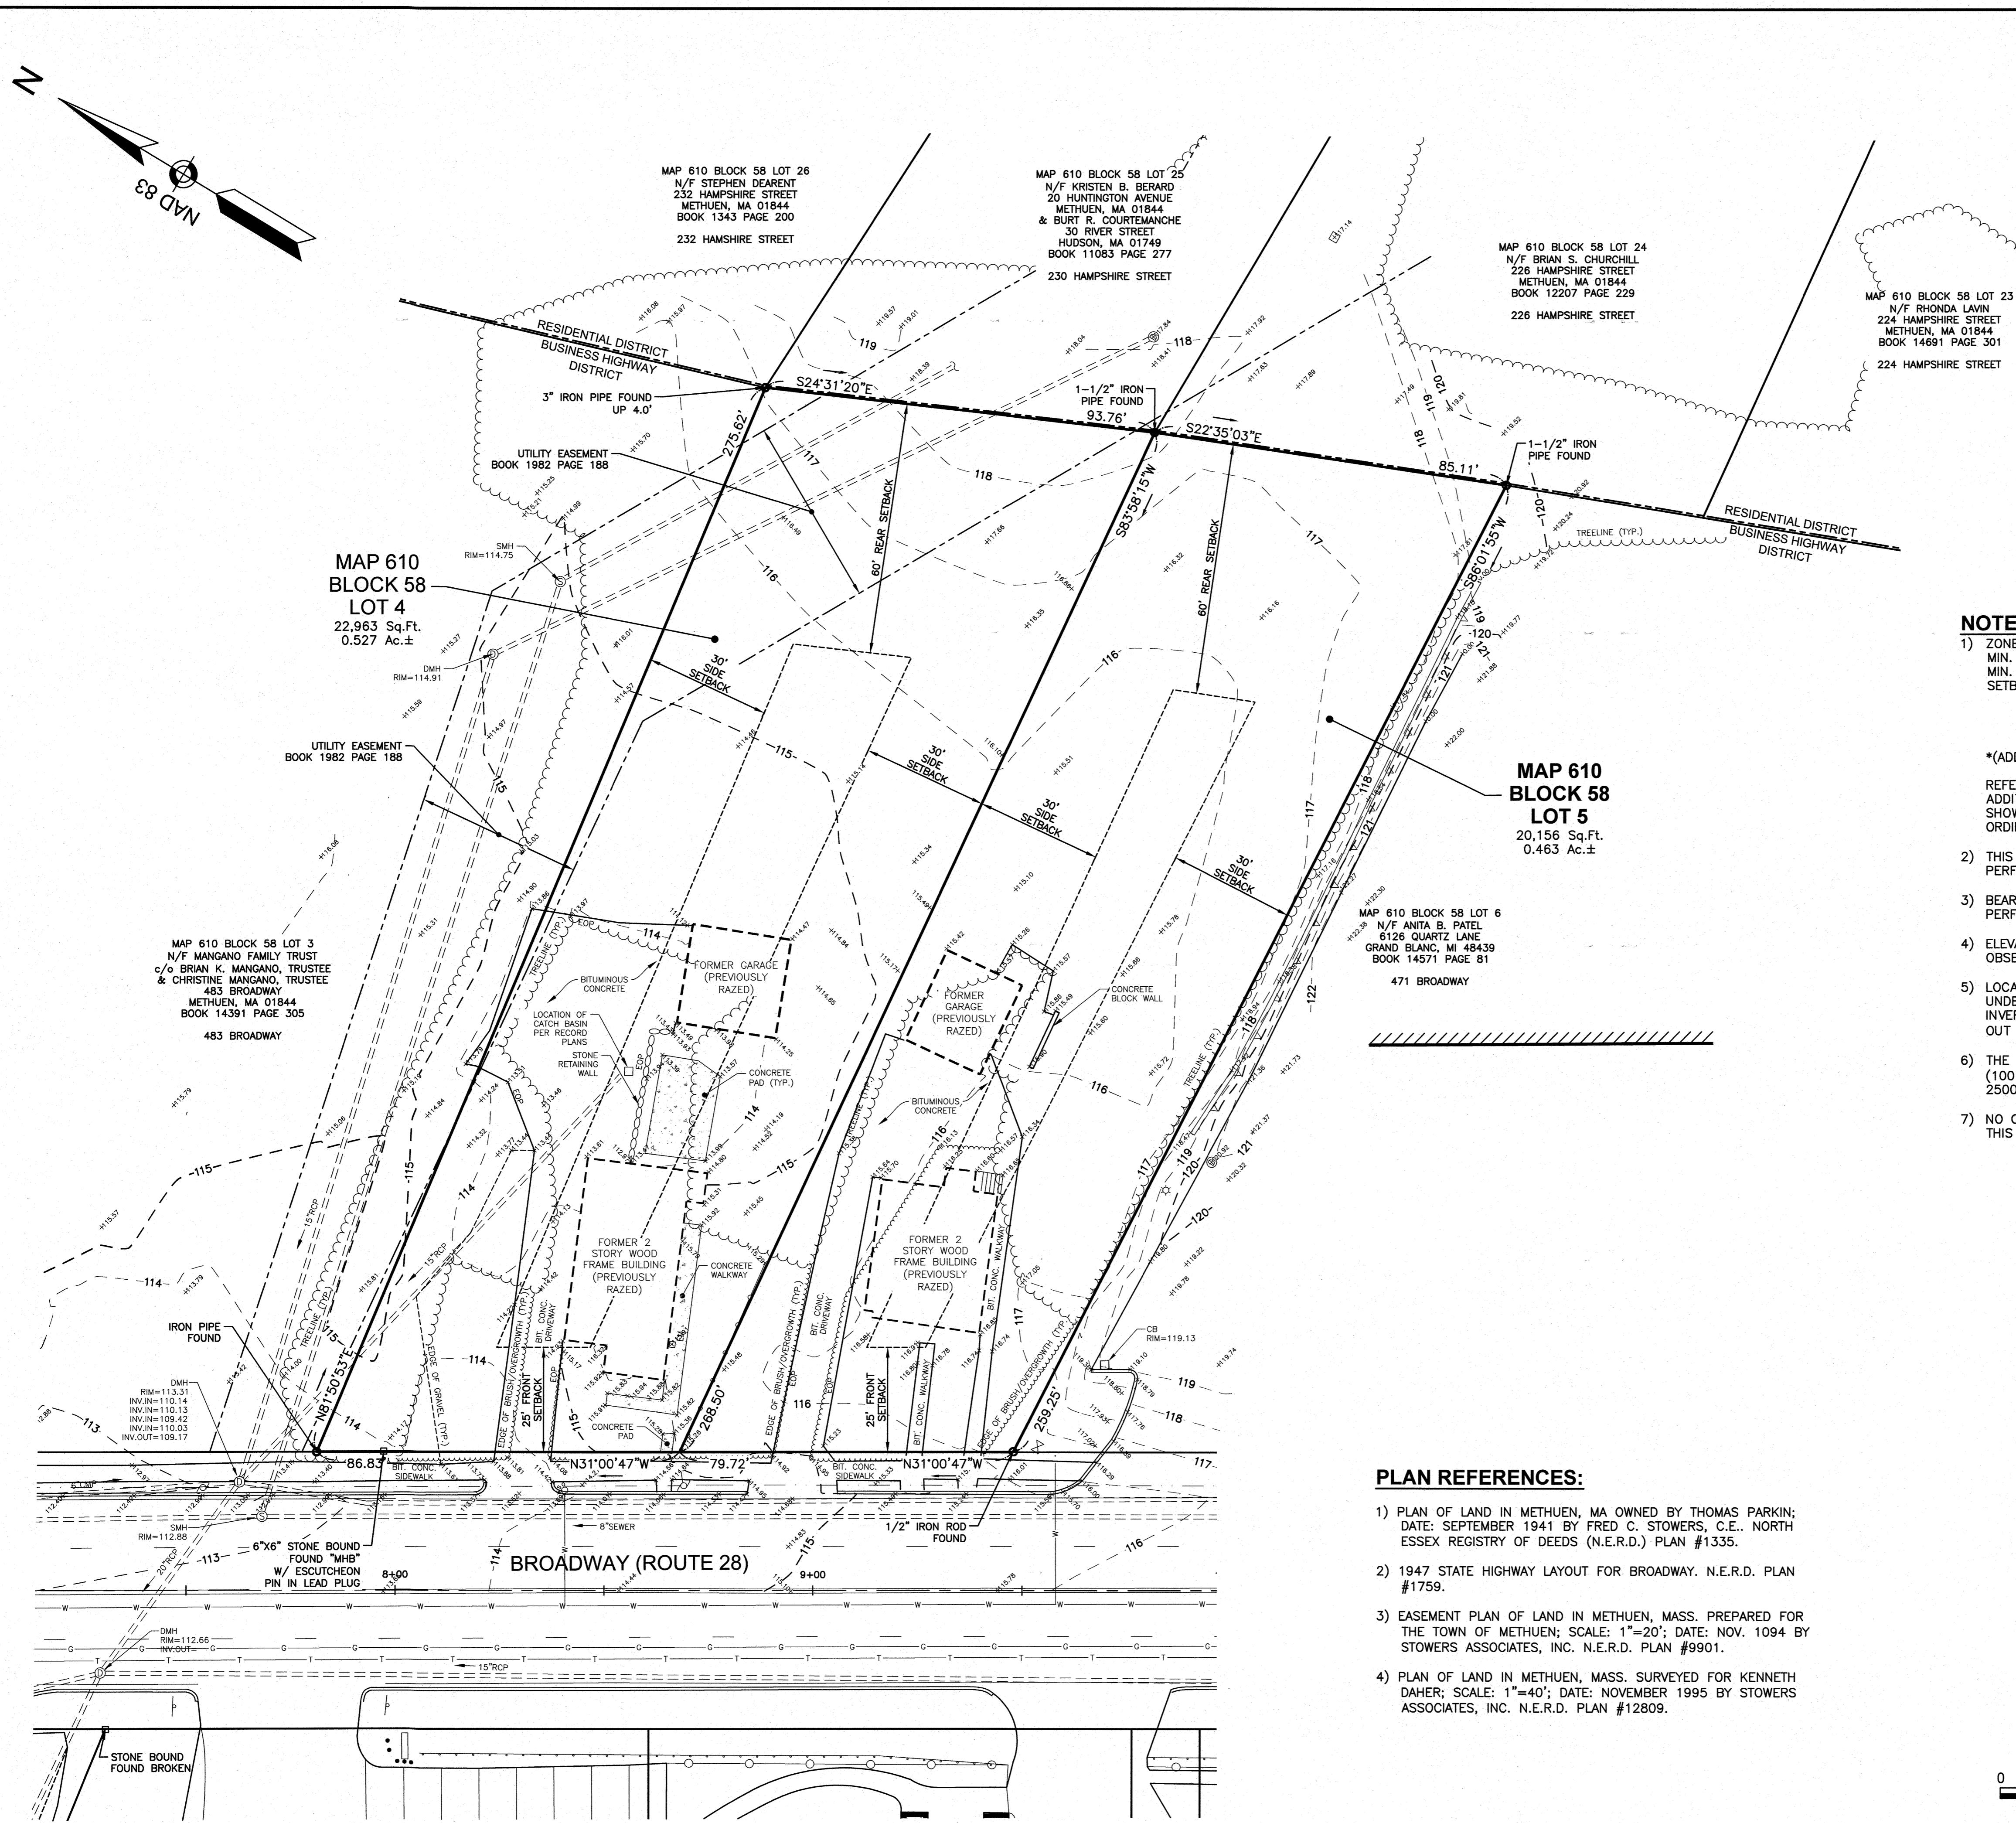
**CONSTRUCTION SEQUENCE:**

- INSTALL TEMPORARY SEDIMENT AND EROSION CONTROL MEASURES AS REQUIRED.
- CUT AND STUMP AREAS OF PROPOSED CONSTRUCTION.
- REMOVE AND STOCKPILE TOPSOIL. STOCKPILE SHALL BE SEDED TO PREVENT EROSION.
- CONSTRUCT CLOSED DRAINAGE SYSTEM. PROTECT CULVERT INLETS AND CATCH BASINS WITH SEDIMENTATION BARRIERS.
- PERFORM SITE GRADING, PLACING SEDIMENT CONTROL FENCES AS REQUIRED TO CONTROL SOIL EROSION.
- INSTALL UNDERGROUND UTILITIES.
- BEGIN TEMPORARY AND PERMANENT SEEDING AND MULCHING. ALL CUT AND FILL SLOPES SHALL BE SEDED OR MULCHED IMMEDIATELY AFTER THEIR CONSTRUCTION.
- DAILY, OR AS REQUIRED, CONSTRUCT, INSPECT, AND IF NECESSARY, RECONSTRUCT TEMPORARY BERMS, DRAINS, DITCHES, SEDIMENT CONTROL FENCES AND SEDIMENT TRAPS INCLUDING MULCHING AND SEEDING. REFER TO OPERATION AND MAINTENANCE PLAN FOR ADDITIONAL REQUIREMENTS AND INFORMATION. COPIES OF ALL INSPECTION REPORTS ARE TO BE PROVIDED TO THE CONSERVATION COMMISSION DURING CONSTRUCTION AND AVAILABLE UPON REQUEST AFTER CONSTRUCTION IS COMPLETED.
- BEGIN EXCAVATION FOR AND CONSTRUCTION OF BUILDINGS.
- FINISH PAVING ALL DRIVES AND PARKING AREAS.
- COMPLETE PERMANENT SEEDING AND LANDSCAPING.
- AFTER GRASS HAS BEEN FULLY GERMINATED IN ALL SEDED AREAS, REMOVE ALL TEMPORARY EROSION CONTROL MEASURES.


**OPERATIONS/MAINTENANCE PLAN FOR STORMWATER SYSTEM:**

CONSTRUCTION PHASE:  
THE BMP'S ASSOCIATED WITH THIS PROJECT WILL BE OWNED BY CAFUA MANAGEMENT COMPANY, LLC WHO WILL BE RESPONSIBLE FOR INSPECTION, OPERATION AND MAINTENANCE.

- THE CONTRACTOR IS TO INSTALL AND MAINTAIN DRAINAGE FACILITIES AS SHOWN ON THE SITE PLANS BY GREENMAN-PEDERSEN, INC.
- PRIOR TO CONSTRUCTION, ALL EROSION/SEDIMENT CONTROL DEVICES SHOWN ON ABOVE PLAN ARE TO BE INSTALLED TO PREVENT SEDIMENT CONTROL INTRUSION INTO SURROUNDING AREAS DURING CONSTRUCTION. THE CONTRACTOR IS TO SET SEDIMENT CONTROL FENCING AT ALL SLOPES WHICH MAY ERODE IN THE DIRECTION OF ANY OPEN DRAINAGE FACILITIES OR ABUTTING PROPERTY. SUCH PREVENTIVE MEASURES ARE TO BE MAINTAINED THROUGHOUT THE CONSTRUCTION PROCESS.
- ALL CONSTRUCTION OF DRAINAGE FACILITIES IS TO BE INSPECTED BY INSPECTORS FROM THE CITY OF METHUEN AND BY AN AUTHORIZED AGENT TO VERIFY CONFORMANCE TO THE DESIGN PLAN.
- THE SEQUENCE OF DRAINAGE CONSTRUCTION SHALL BE AS FOLLOWS:
  - CLEAR, GRUB, EXCAVATE AREAS FOR DETENTION SYSTEMS.
  - INSTALL CATCH BASINS, PIPES AND MANHOLES.
- EROSION CONTROLS ARE TO BE INSPECTED AND MAINTAINED ON A DAILY BASIS. UPON DISCOVERY OF SEDIMENT CONTROL BUILD-UP IN ANY CATCH BASIN SUMP OR ANY OTHER STRUCTURE, CLEANING SHALL BE PERFORMED WITHIN 24 HOURS.
- ALL EXPOSED SOILS SHALL BE IMMEDIATELY STABILIZED WITH A LAYER OF MULCH HAY.
- UPON INSTALLATION OF CATCH BASINS, INLET PROTECTION – AS DESCRIBED ON AFOREMENTIONED PLAN –



**ASSESSORS MAP 610 BLOCK 58 LOTS 4 & 5**  
**477 & 479 BROADWAY**  
**METHUEN, MASSACHUSETTS**

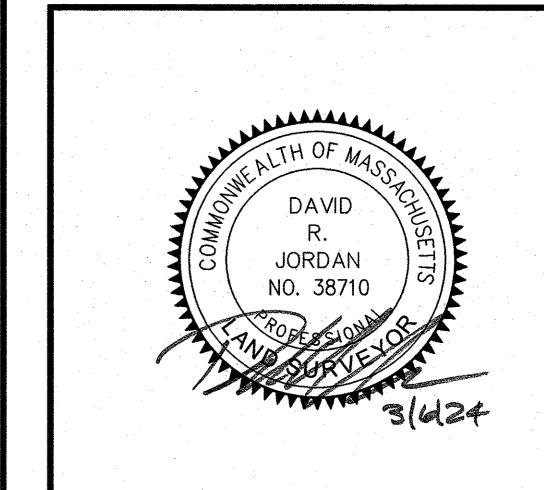

REVISIONS		
NO.	REVISION	DATE
		MARCH 6, 2024

DRAWN/DESIGN BY **SJB/CMT** CHECKED BY **DRJ**

**OWNER OF RECORD:**

MAP 610 BLOCK 58 LOT 4  
CAFUA REALTY TRUST XXV LLC  
280 MERRIMACK STREET  
METHUEN, MA 01844  
BOOK 13846 PAGE 311

MAP 610 BLOCK 58 LOT 5  
CAFUA REALTY TRUST XXV LLC  
280 MERRIMACK STREET  
METHUEN, MA 01844  
BOOK 13846 PAGE 296

0 20 50 100  
SCALE: 1" = 20'

**EXISTING CONDITIONS PLAN**


SCALE:  
1" = 20'  
PROJECT NO.  
NEX-2021347

## **NOTES:**

1) SEE SHEET 2 FOR NOTES AND LEGEND INFORMATION.

PREPARED FOR  
CAFUA MANAGEMENT  
COMPANY, LLC  
280 MERRIMACK STREET  
METHUEN, MA 01844

**ASSESSORS MAP 610 BLOCK 58 LOTS 4 & 5  
477 & 479 BROADWAY  
METHUEN, MASSACHUSETTS**

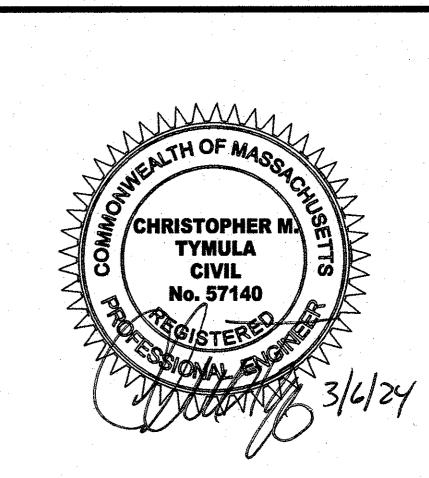

# DEMOLITION PLAN

SCALE: 1"=20'  
PROJECT NO. NEX-2021347

4 OF 14



0 20 50 100  
SCALE: 1" = 20'

A scale bar and text block. The scale bar is a horizontal line with tick marks at 0, 20, 50, and 100. Below the scale bar is the text "SCALE: 1" = 20'".

F:\Projects\NEX-2021347 - Methuen, MA - Cafua Management (Old 351314)\CAD Files\21347\_SP.dwg DEMO 3/05/24 4:46pm cmason


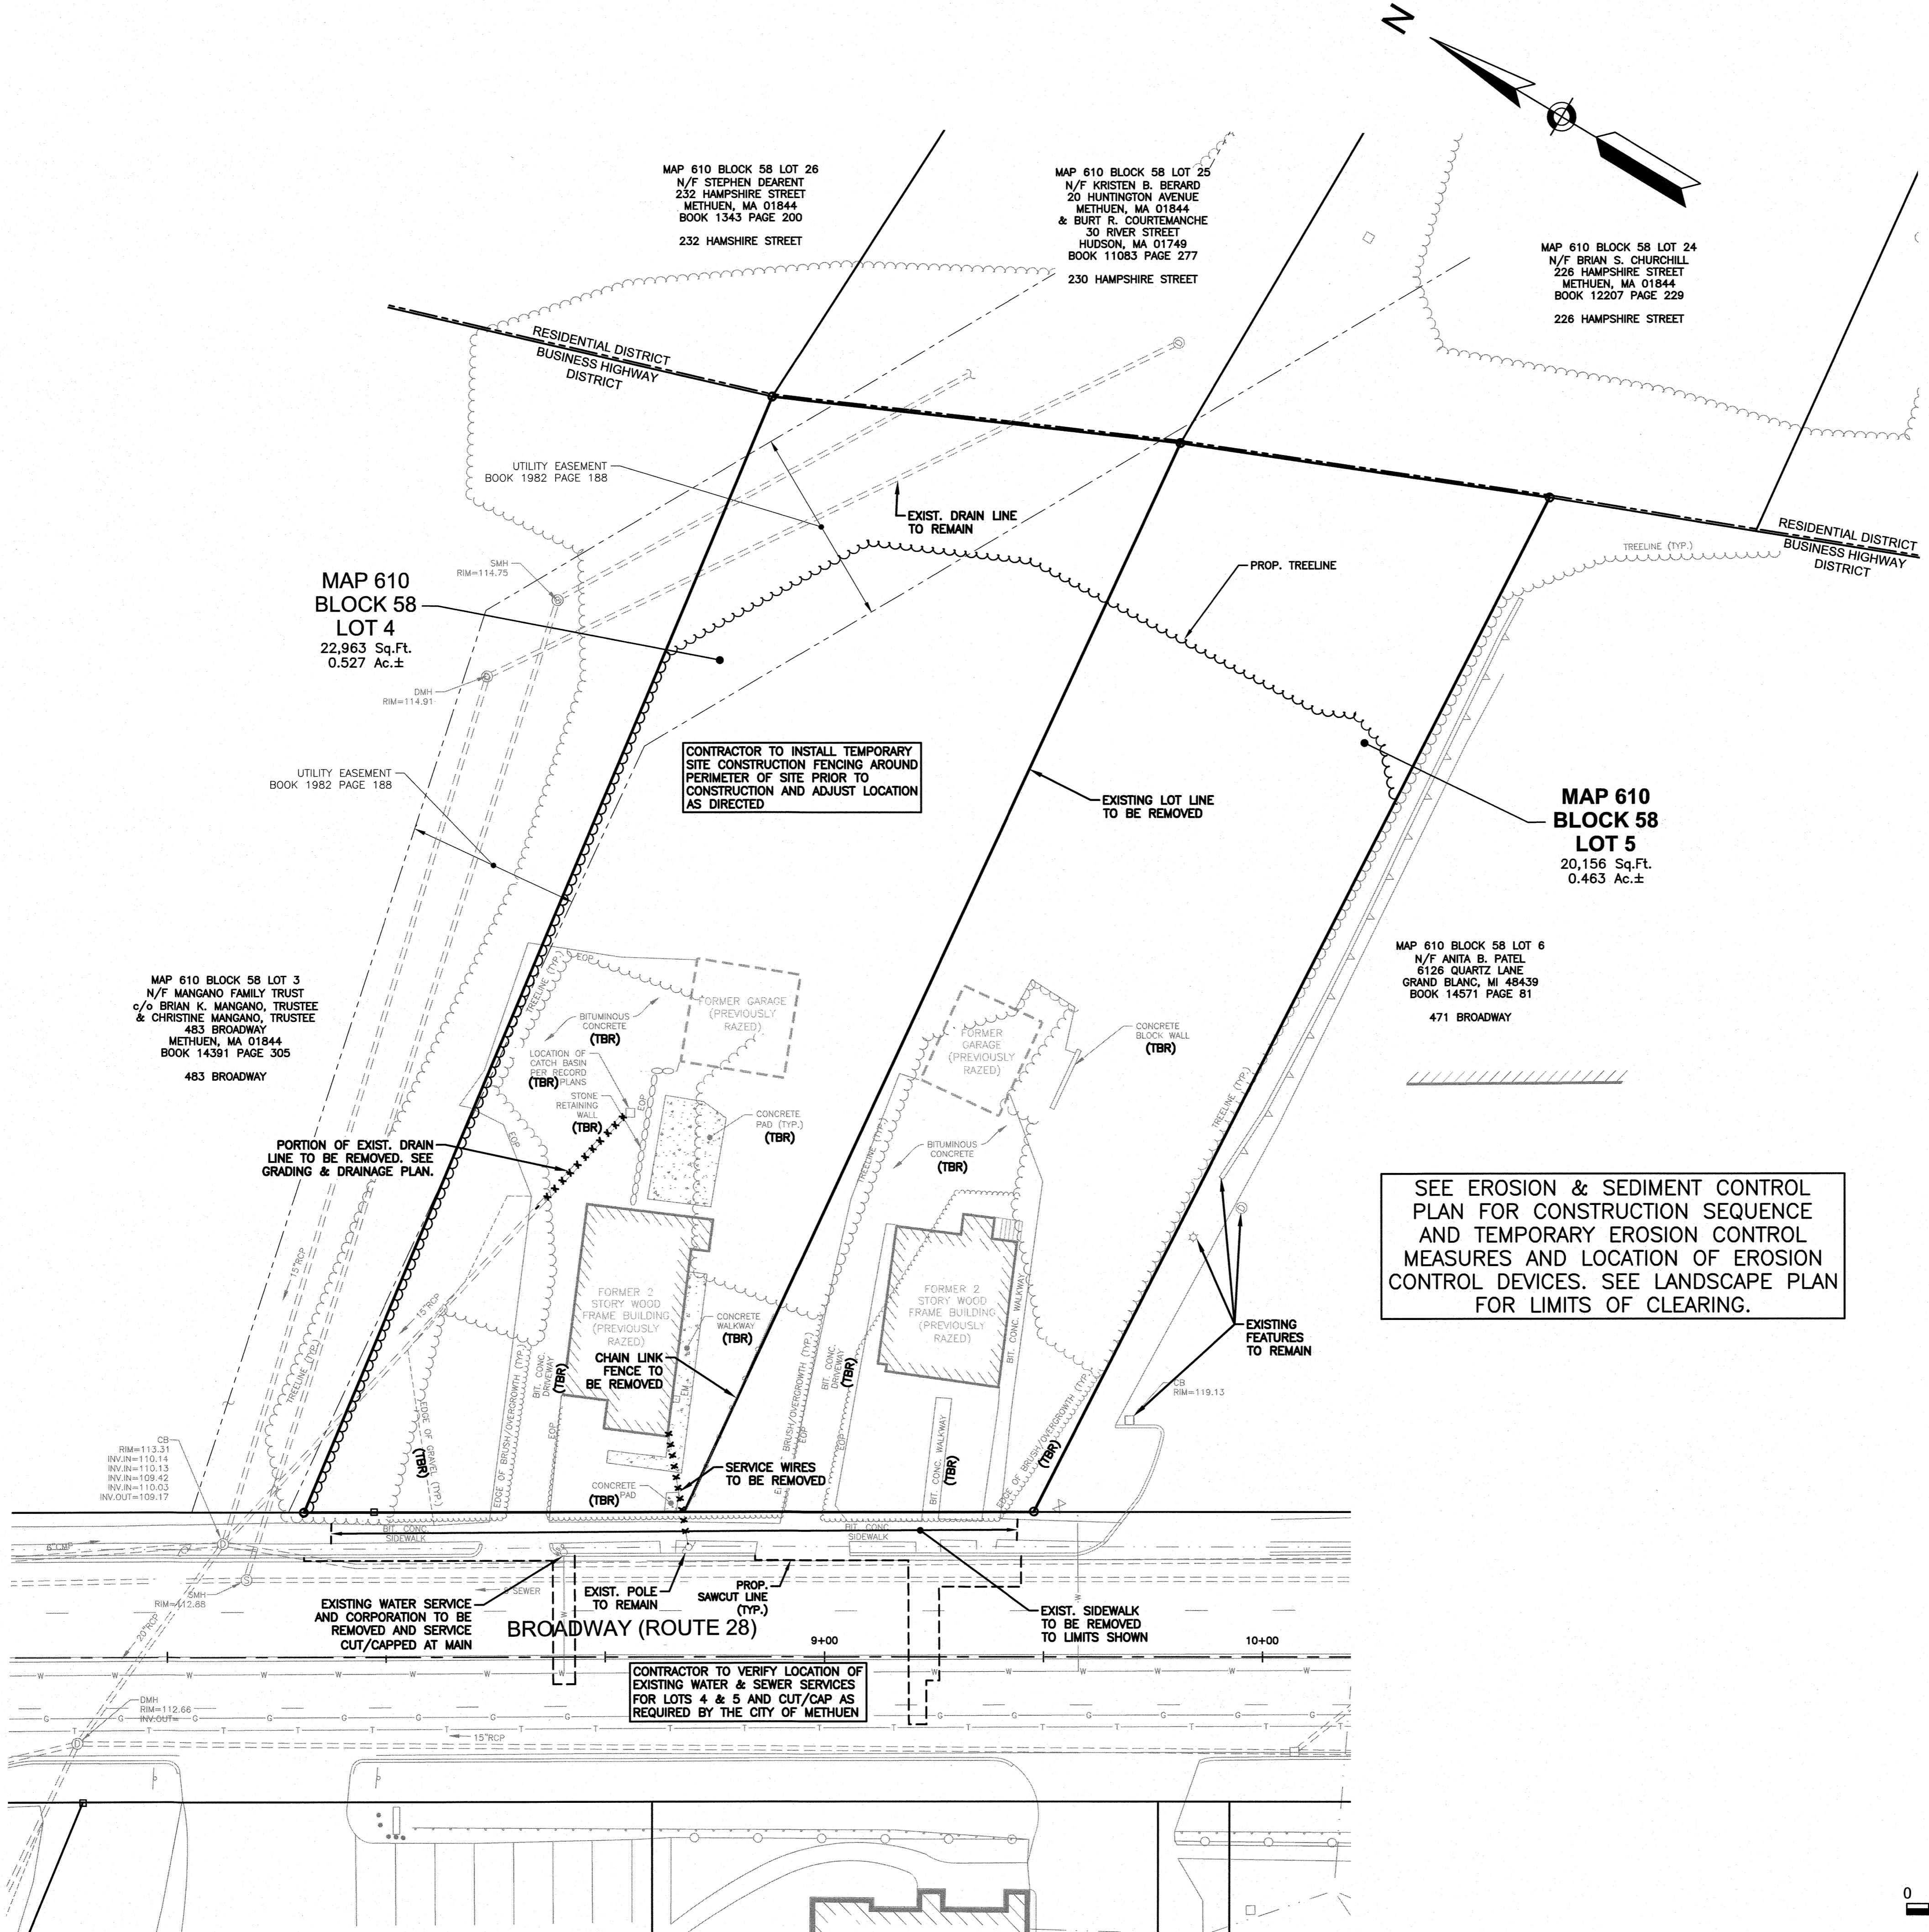


TABLE OF ZONING REGULATIONS		
DESCRIPTION	REQUIRED	PROVIDED
MINIMUM LOT AREA, Sq. Ft.	10,000 SF	43,119 SF
MINIMUM LOT FRONTAGE	100'	165'
MINIMUM FRONT YARD BUILDING SETBACK	25'	83'
MINIMUM REAR YARD BUILDING SETBACK (ABUTTING RESIDENTIAL ZONE)	60'	103.3'
MINIMUM SIDE YARD BUILDING SETBACK	30'	36.6'
MINIMUM FRONT YARD PARKING SETBACK	15'	15'
MINIMUM REAR YARD PARKING SETBACK	7.5'	N/A
MINIMUM SIDE YARD PARKING SETBACK (ALSO 7.5' FROM BUILDINGS)	7.5'	38.9'
MINIMUM BUFFER FROM RESIDENTIAL	30'	33.9'
PARKING SPACE DIMENSIONS	9' X 18'	9' X 18'
MINIMUM NUMBER PARKING SPACES	20 SPACES	
DONUT SHOP (2,100 SF, 24 SEATS)		
1 SF/ SEATS x 24 SEATS = 6 SPACES		
1 SP/2 EMP. x 6 EMP. = 3 SPACES		
TOTAL REQUIRED	= 9 SPACES	
MAXIMUM BUILDING HEIGHT	40' (3 STORIES)	< 40'
MAXIMUM BUILDING COVERAGE	35%	2,100 SF/43,119 SF = 4.9%
MAXIMUM FREESTANDING SIGN AREA, HEIGHT AND SETBACK	60 SF, 20' HEIGHT (ONE SIGN PER BUILDING)	REFER TO PROPOSED PYLON SIGN
MAXIMUM WALL SIGN AREA	33% OF WALL	REFER TO EXTERIOR ELEVATIONS


SIGN KEY		
SIGN I.D. NUMBER	TEXT/COLOR	SIZE/REMARKS
R1-1	STOP R/W	30" x 30" NEW SIGN WITH POST
R7-8	RESERVED G/B/W	12" x 18" NEW SIGN WITH POST
R7-8A	ACCESSIBLE G/W	6" x 12"
R5-1	DO NOT ENTER R/W	30" x 30" NEW SIGN WITH POST
R3-1	WHEELCHAIR B/W/R	24" x 24" NEW SIGN WITH POST



#### FOR REGISTRY USE

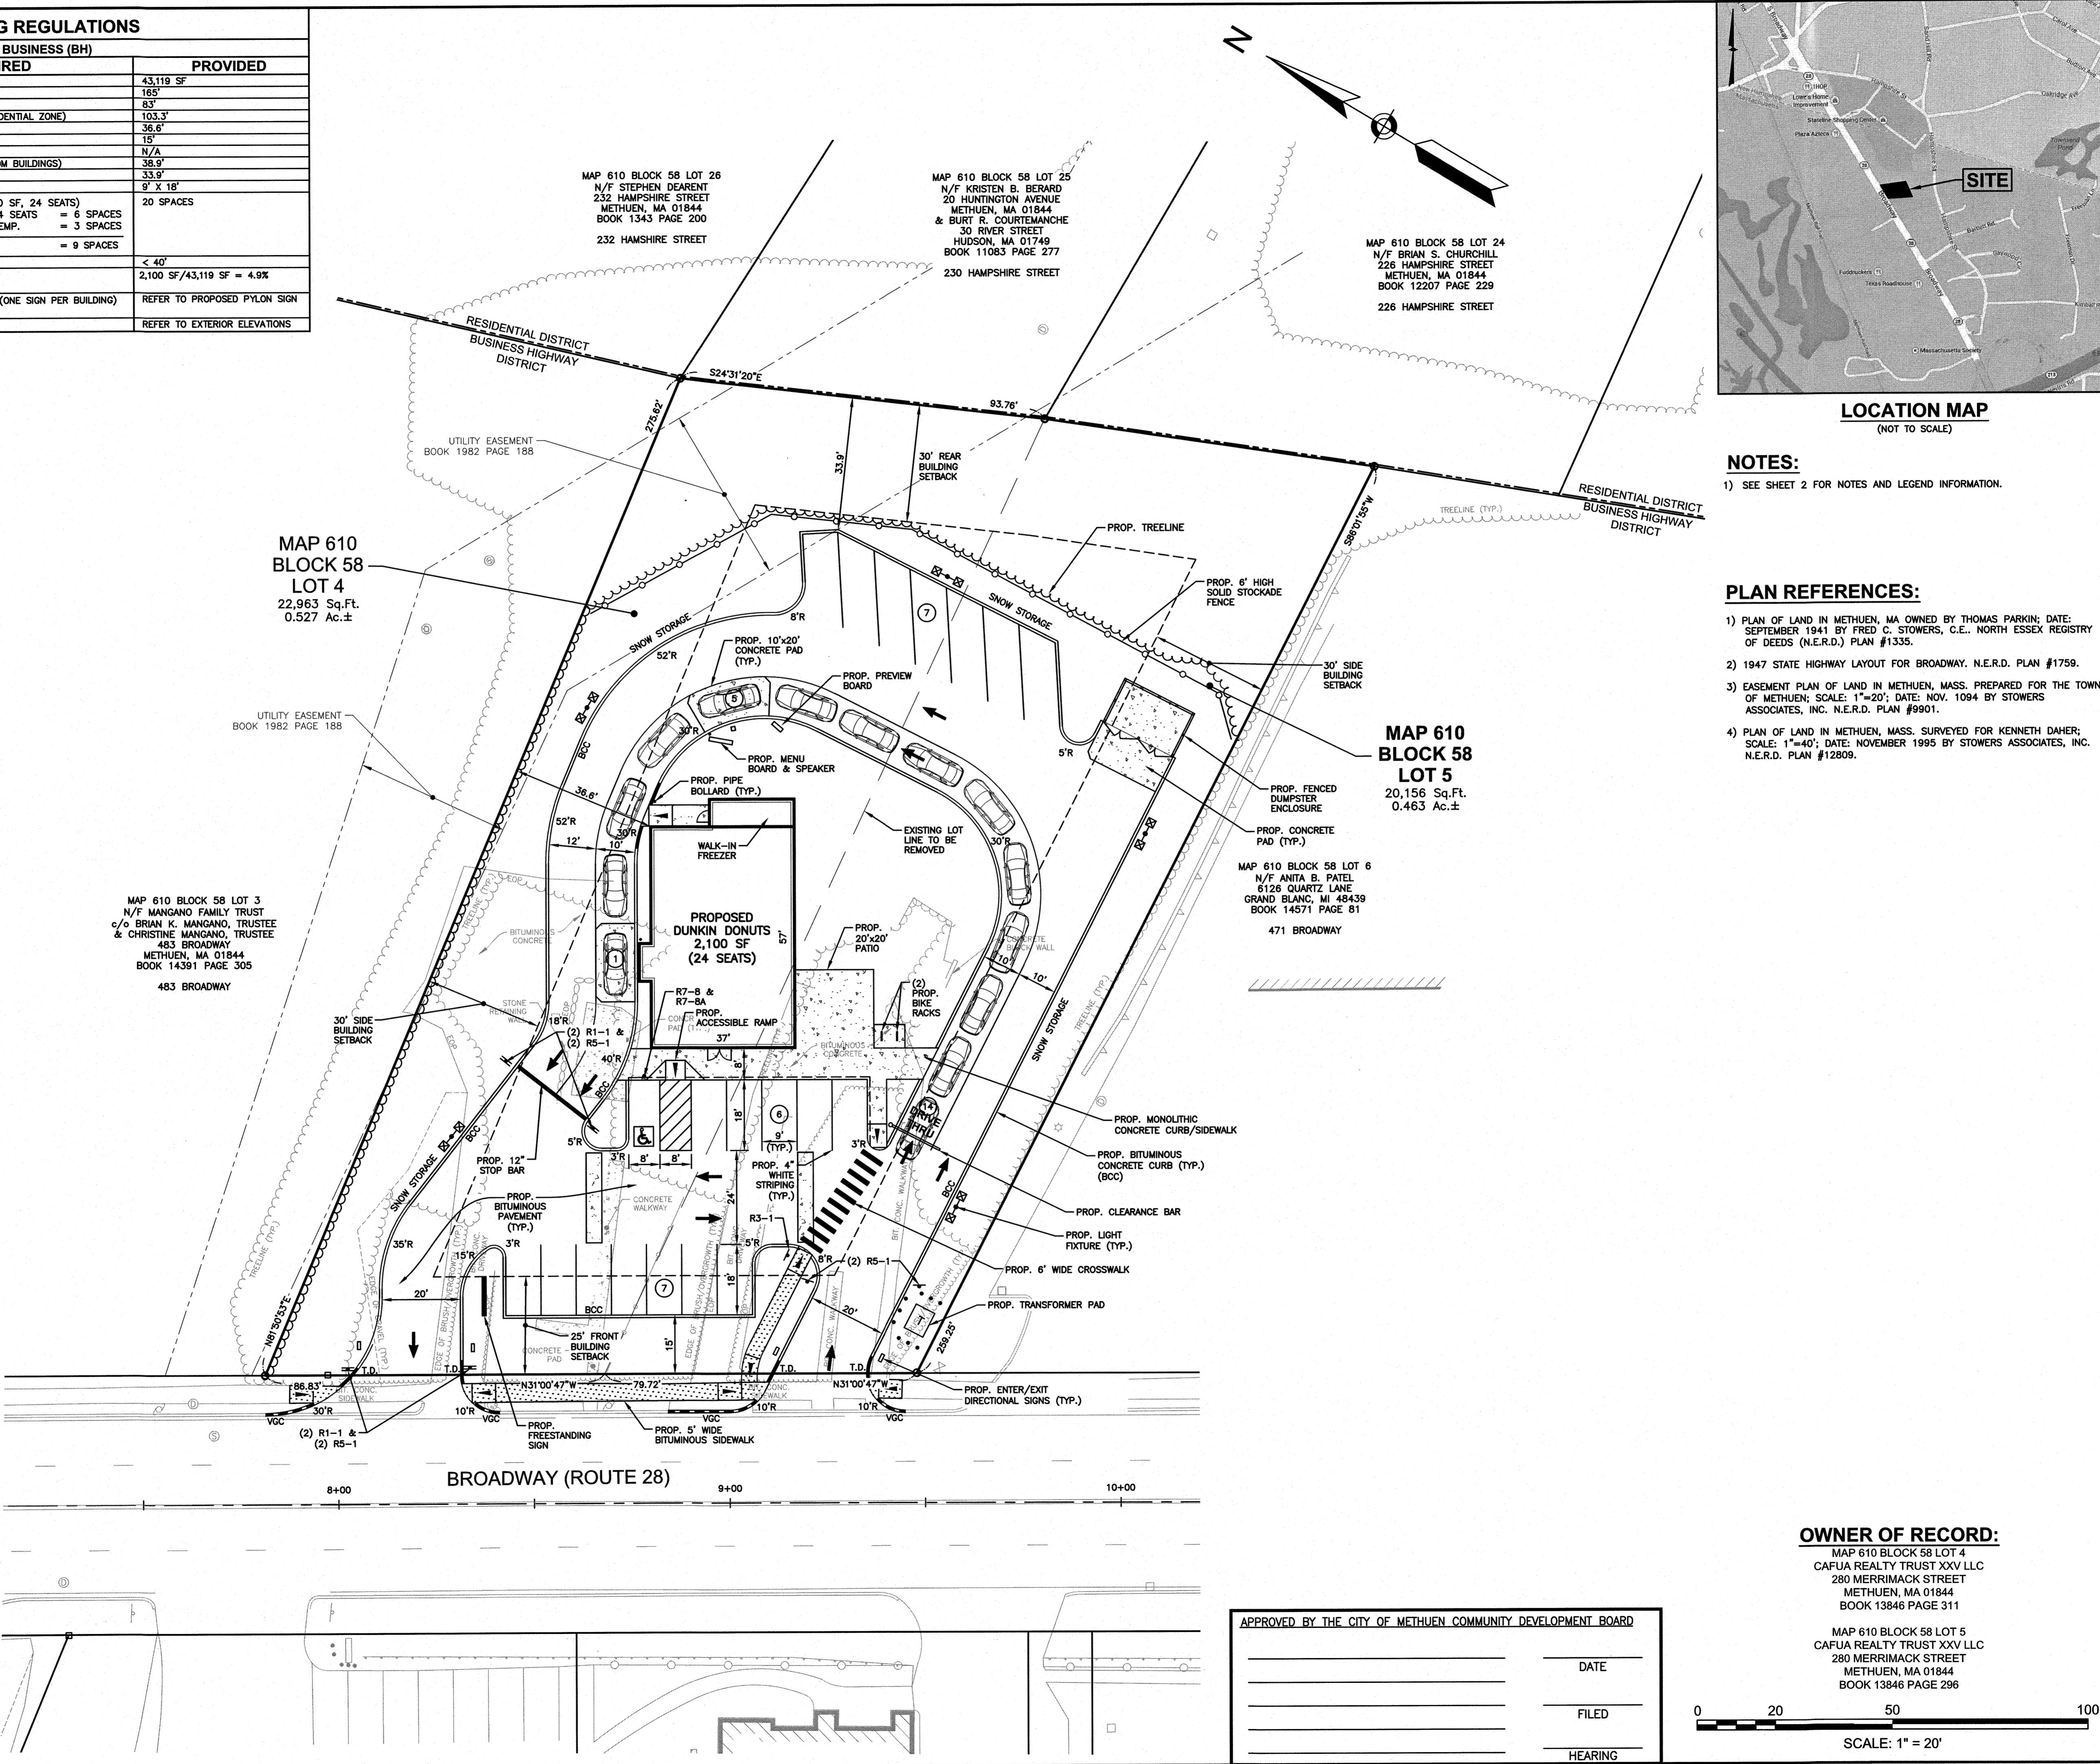


## ASSESSORS MAP 610 BLOCK 58 LOTS 4 & 5 477 & 479 BROADWAY METHUEN, MASSACHUSETTS

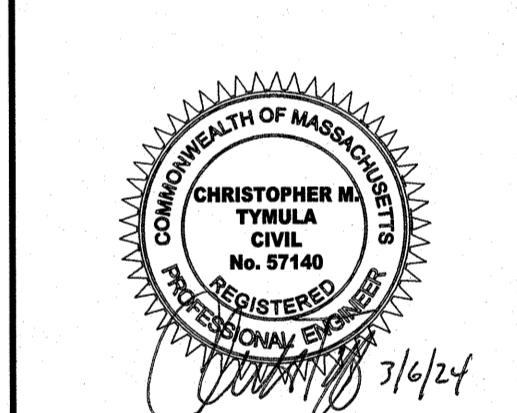


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NO.	REVISION	DATE
		MARCH 6, 2024

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CHECKED BY CMT

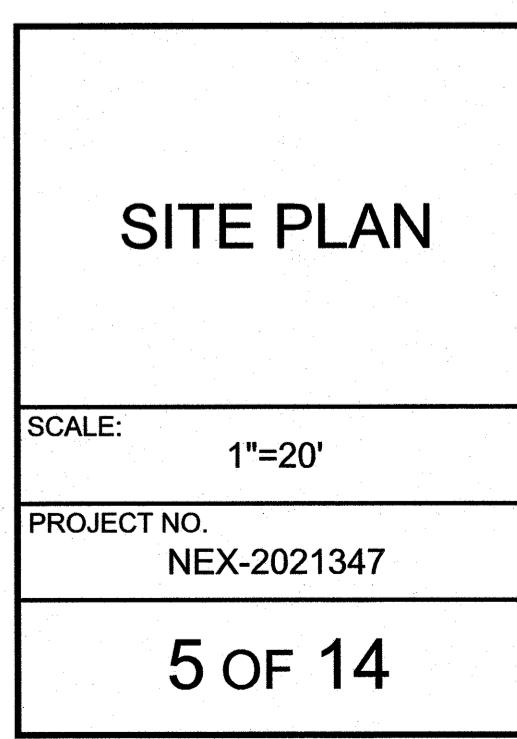

**ASSESSORS MAP 610 BLOCK 58 LOTS 4 & 5  
477 & 479 BROADWAY  
METHUEN, MASSACHUSETTS**

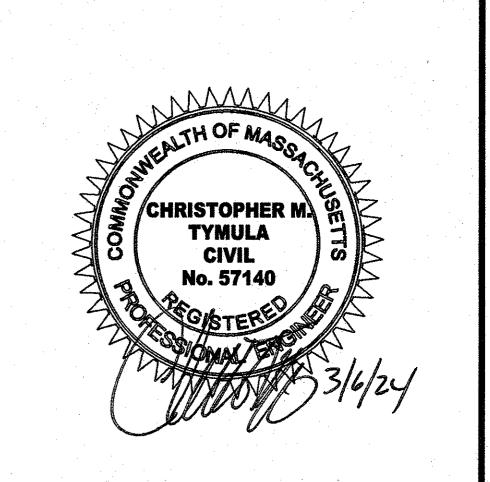

REVISIONS		
NO.	REVISION	DATE

MARCH 6, 2024

DRAWN/DESIGN BY SJB/CMT CHECKED BY CMT

GRADING & DRAINAGE PLAN	
SCALE:	1" = 20'
PROJECT NO.	NEX-2021347
HEARING	SCALE: 1" = 20'
DATE	0 20 50 100
FILED	

6 OF 14

DRAINAGE PIPE SCHEDULE					
FROM: STRUCTURE NUMBER	PIPE SIZE (INCHES)	TYPE OF PIPE	APPROX. PIPE LENGTH (FEET)	SLOPE OF PIPE (FT./FT.)	TO: STRUCTURE NUMBER
CB-1	12	HDPE	94	0.007	DMH-1
CB-2(FD)	12	HDPE	34	0.006	DET IN2
CB-3(FD)	12	HDPE	38	0.005	DET IN1
DET OUT	24	HDPE	24	0.000	INF IN
DMH-1	12	HDPE	15	0.017	DMH-2
OCS-1	12	HDPE	21	0.048	DMH-3

**DRAINAGE STRUCTURES**

CB-1  
RIM=116.10  
INV.OUT=113.10  
DMH-3  
RIM=115.60  
INV.IN=112.10(OCS-1)  
INV.OUT=110.65±(EX.)  
\*CB-2(FD)  
RIM=115.15  
INV.OUT=112.20  
CB-3(FD)  
RIM=115.00  
INV.OUT=112.20  
(SEE DETAIL)  
CB-4  
RIM=116.00  
INV.OUT=113.00  
DMH-1  
RIM=116.45  
INV.N=112.45(CB-1)  
INV.N=112.60(CB-4)  
INV.OUT=112.35  
DMH-2  
RIM=116.75  
INV.N=112.10(DMH-1)  
INV.N=113.75(FD)  
INV.OUT=112.10(12"LOW)  
INV.OUT=113.04(12"MANIFOLD)  
\* DENOTES LOW PROFILE FRAME &  
GRATE  
(FD) DENOTES FIRST DEFENSE  
FIRE HYDROSTATIC SEPARATOR  
BY HYDRO INTERNATIONAL OR  
APPROVED EQUAL  
(ST) DENOTES SOILIGHT PIPE JOINTS

**MAP 610  
BLOCK 58  
LOT 4**

22,963 Sq.Ft.  
0.527 Ac.±

MAP 610 BLOCK 58 LOT 3  
N/F MANGANO FAMILY TRUST  
c/o BRIAN K. MANGANO, TRUSTEE  
& CHRISTINE MANGANO, TRUSTEE  
483 BROADWAY  
METHUEN, MA 01844  
BOOK 14391 PAGE 305

483 BROADWAY  
INSTALL ON EXIST. 15" RCP DRAIN  
LINE. CONTRACTOR TO FIELD LOCATE  
EXIST. DRAIN LINE AND VERIFY  
LOCATION AND DEPTH. NOTIFY ENGINEER  
OF CONSTRUCTION OF  
ANY DISCREPANCIES.

GRADE TO DRAIN (TP.)


GRADE BREAK

&lt;p

**NOTES:**  
1) SEE SHEET 2 FOR NOTES AND LEGEND INFORMATION.

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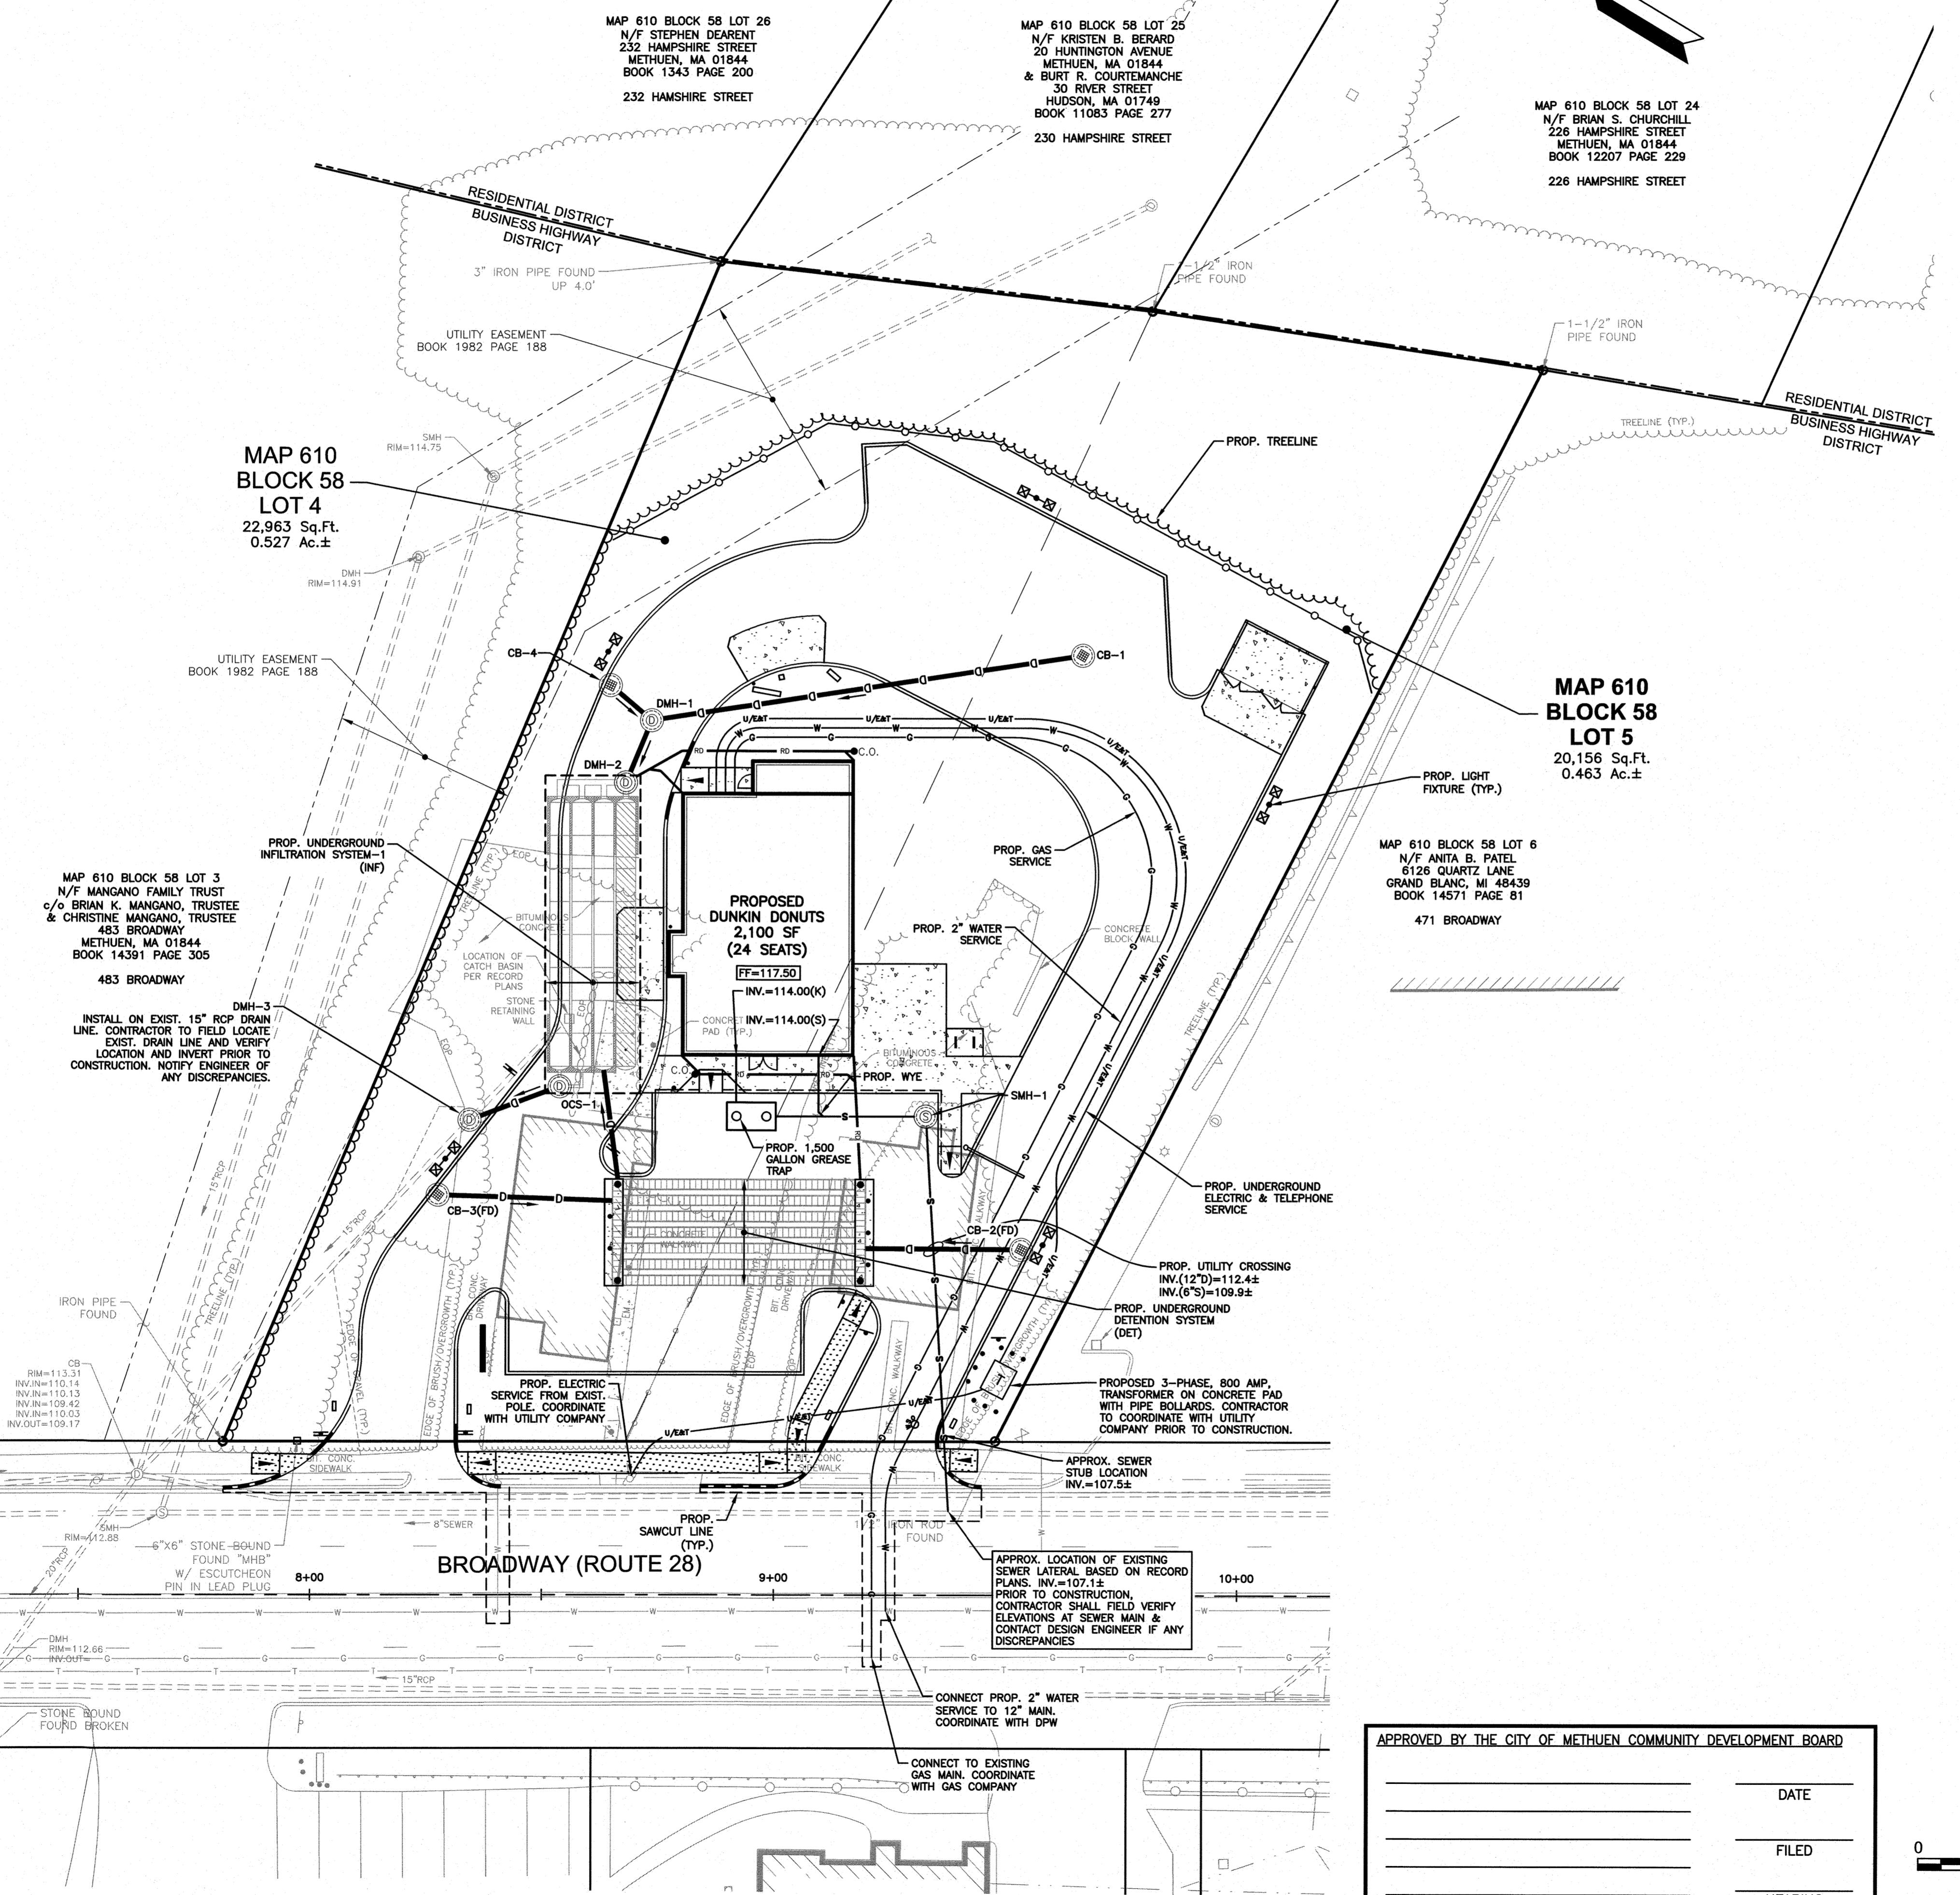
**ASSESSORS MAP 610 BLOCK 58 LOTS 4 & 5  
477 & 479 BROADWAY  
METHUEN, MASSACHUSETTS**

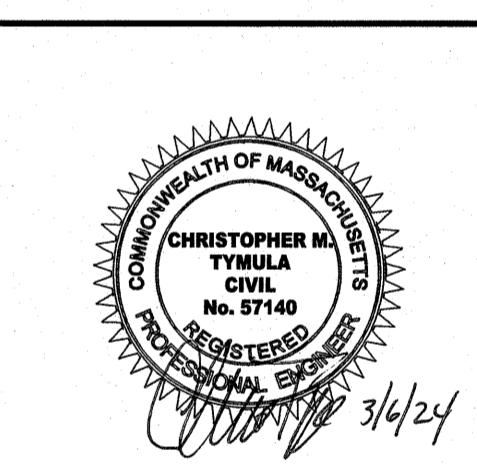

SEWER PIPE SCHEDULE					
FROM STRUCTURE NUMBER	PIPE SIZE (inches)	TYPE OF PIPE	APPROX. PIPE LENGTH (feet)	SLOPE OF PIPE (H/L)	TO STRUCTURE NUMBER
BLDG.	4	PVC	10	0.020	GR. TRAP #1
GR. TRAP #1	4	PVC	33	0.050	SMH-1
BLDG.	6	PVC	13	0.073	WYE
SMH-1	6	PVC	68	0.063	STUB

**SEWER STRUCTURES**

1,500 GAL. GREASE TRAP #1  
RIM=116.80  
INV.=113.80  
INV.OUT=113.55  
  
SMH-1  
RIM=116.60  
INV.=111.90  
INV.OUT=111.80




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METHUEN, MA 01844

# ASSESSORS MAP 610 BLOCK 58 LOTS 4 & 5

# 477 & 479 BROADWAY METHUEN, MASSACHUSETTS



## REVISIONS
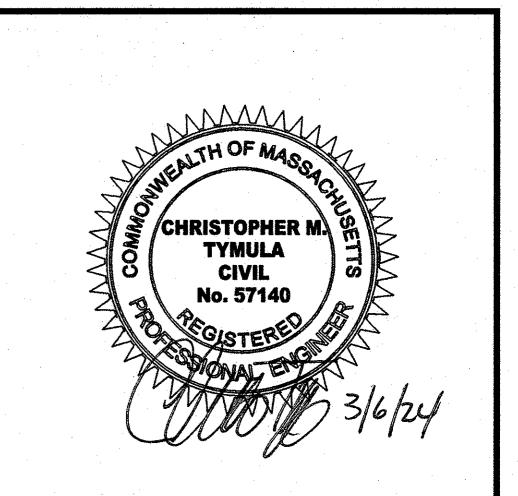
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<b>MARCH 6, 2024</b>		
DRAWN/DESIGN BY		CHECKED BY
SJB/CMT		CMT

# EROSION & SEDIMENT CONTROL PLAN

**SCALE:**

1"=20'

PROJECT NO. **NEX-2021347**

## REFERENCES

8 OF 14

10. *What is the name of the author of the book you are reading?*


8 OF 14

8 OF 14


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PLANTING SCHEDULE					
PLANT	QNTY	BOTANICAL NAME	COMMON NAME	MIN. INSTALL SIZE	REMARKS
<b>TREES</b>					
AR	2	ACER RUBRUM 'KARPICK'	KARPICK RED MAPLE	2"-2 1/2" CAL., B&B	
AM	9	AMELANCIER CANADENSIS	SERVICEBERRY	6'-7' HT., B&B	CLUMP
GT	3	GLEDTISIA TRIACANTHOS 'STREET KEEPER'	STREET KEEPER HONEY LOCUST	2"-2 1/2" CAL., B&B	
<b>SHRUBS</b>					
IG	37	ILEX GLabra 'SHAMROCK'	SHAMROCK INKBERRY	2'-3' HT., 3 GAL.	
TO	13	THUJA OCCIDENTALIS 'SMARAGD'	EMERALD GREEN ARBORVITAE	5'-6' HT., B&B	
SG	24	SPIREA BUMALDA 'GOLDFLAME'	GOLDFLAME SPIREA	2'-3' HT., 3 GAL.	
<b>PERENNIALS &amp; GRASSES</b>					
HD	26	HEMEROCALLIS 'STELLA DE ORO'	DWARF YELLOW DAYLILY	1 GAL.	
NW	21	NEPETA 'WALKER'S LOW'	WALKER'S LOW CATMINT	1 GAL.	
PH	39	PENNISETUM ALOPERCUROIDES 'HAMELN'	DWARF FOUNTAIN GRASS	1 GAL.	

1 XX	PLANT QUANTITY PLANT DESIGNATION		PROPOSED LOAM AND SEED		PROPOSED LANDSCAPE STONE
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## **NOTES:**


1) SEE SHEET 2 FOR NOTES AND LEGEND INFORMATION.

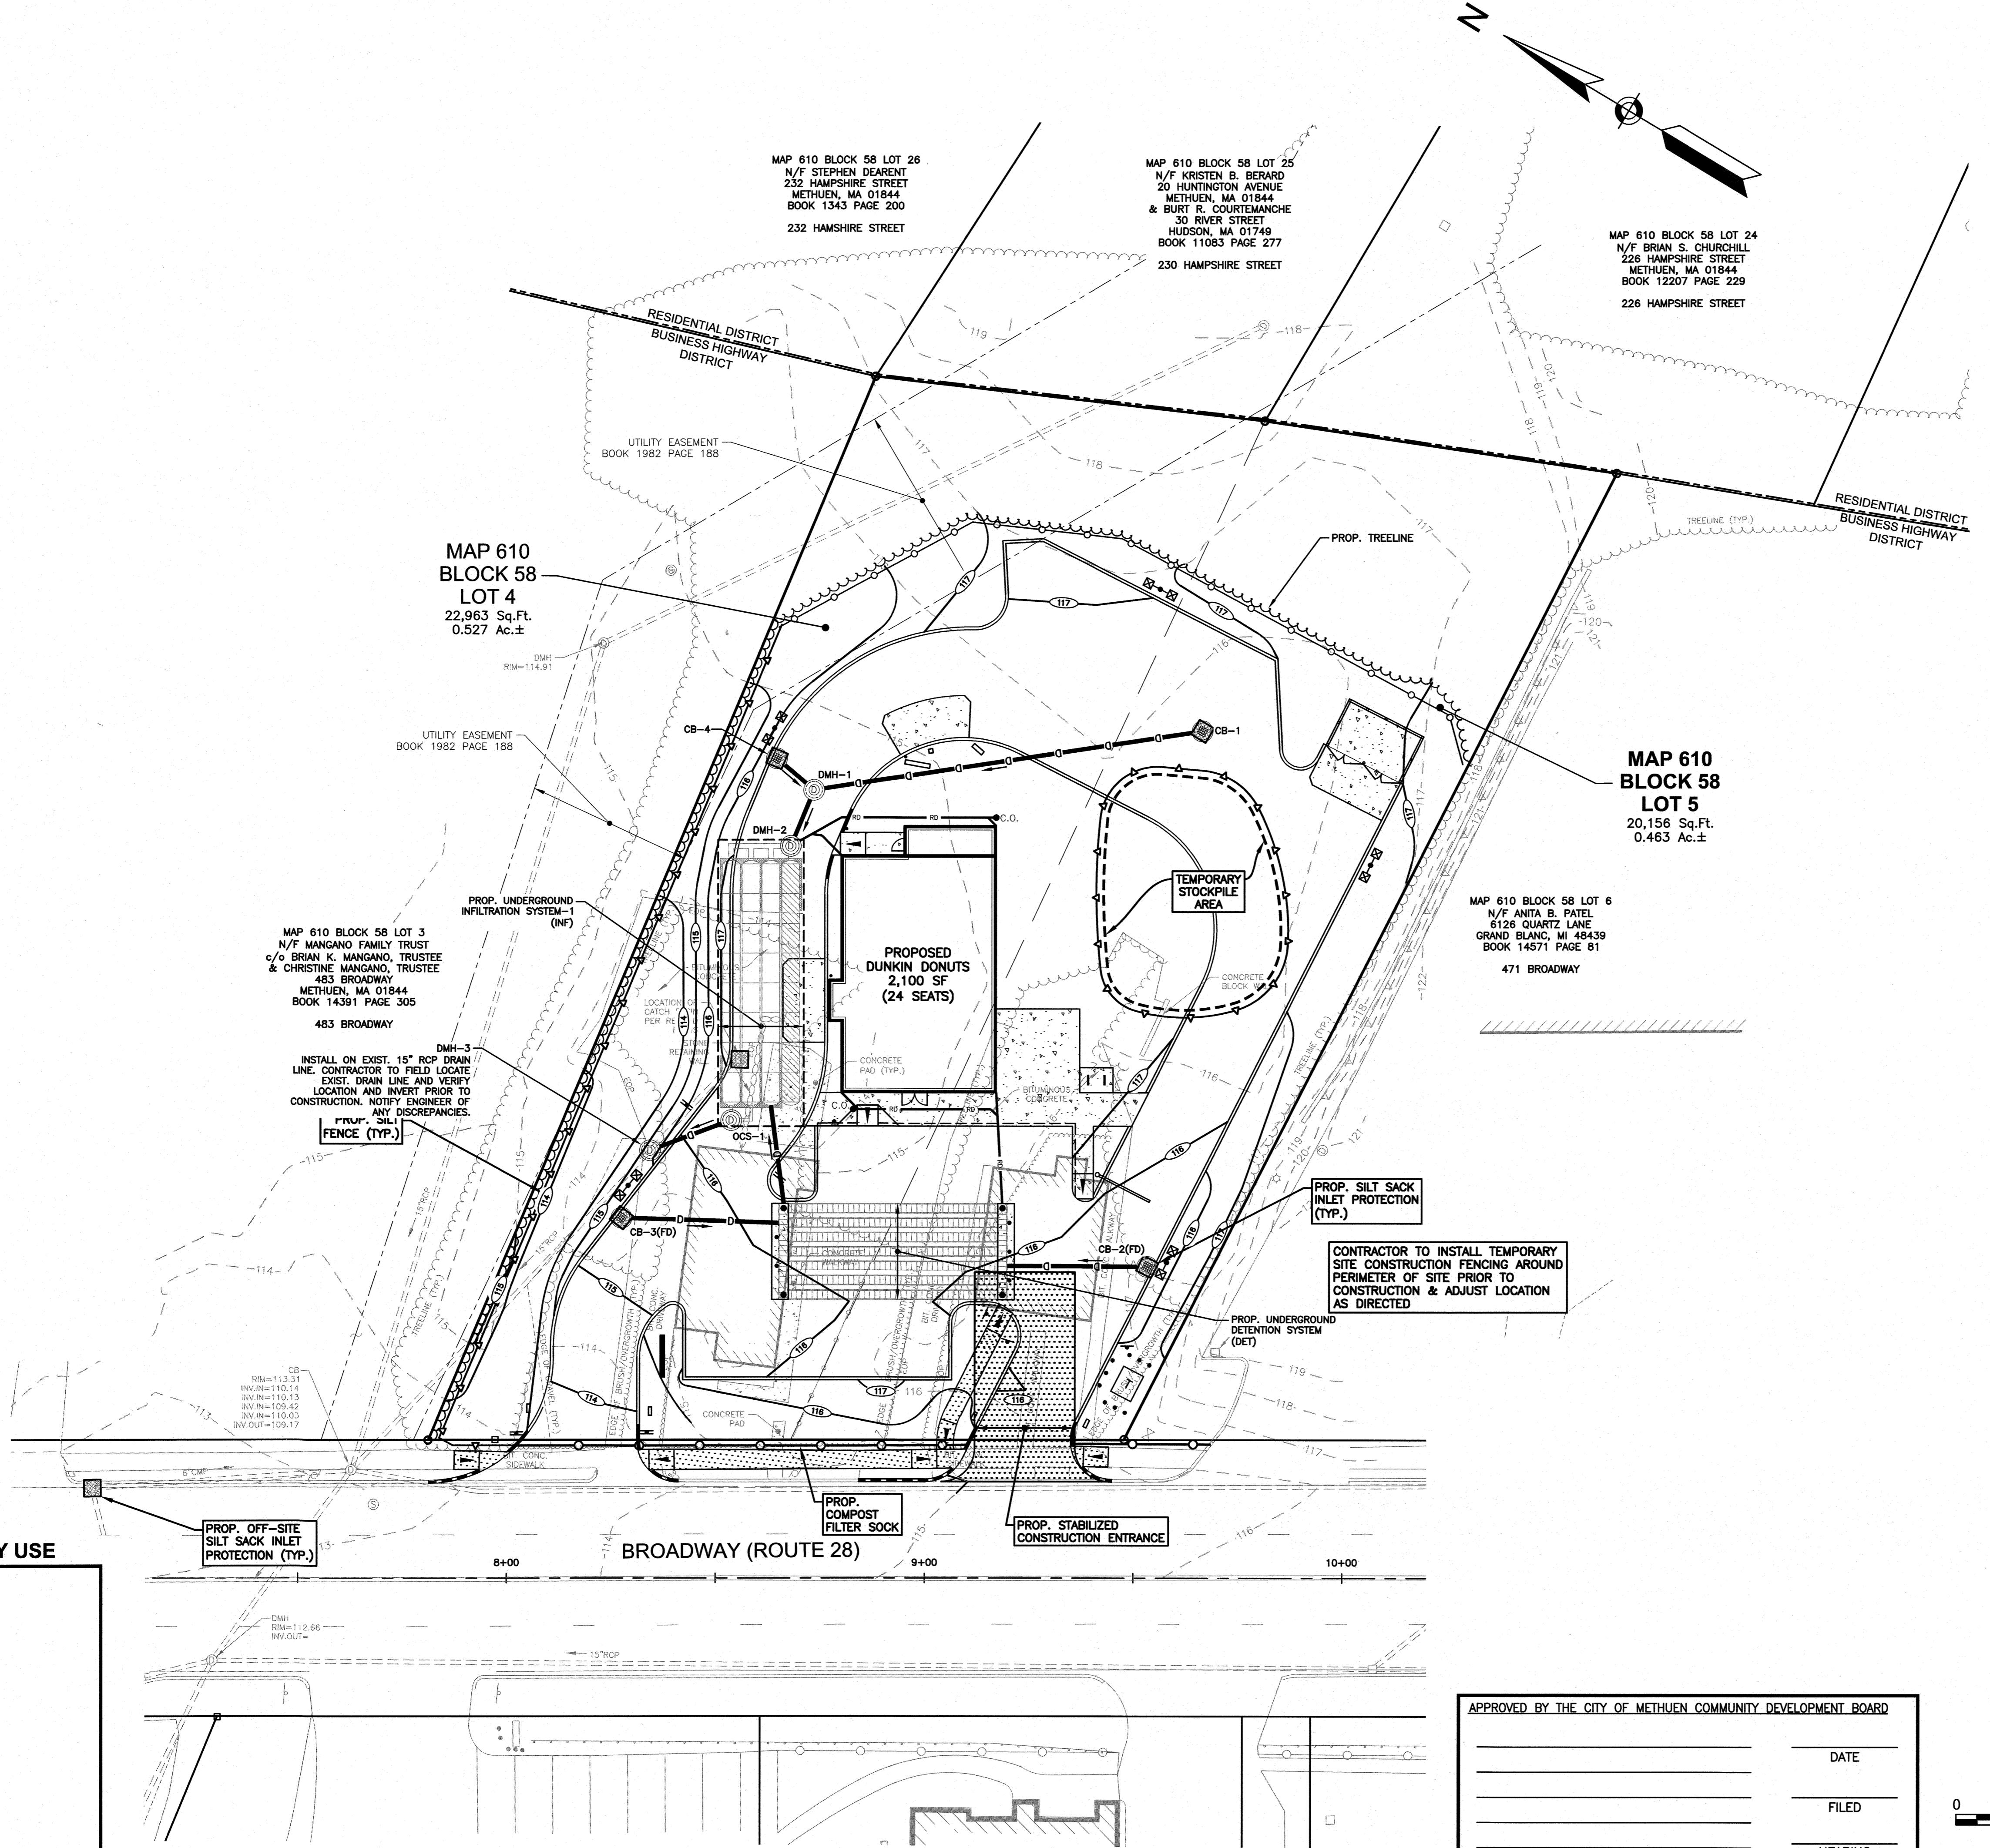The logo for GPI, featuring the letters 'GPI' in a large, bold, black, sans-serif font. To the right of the letters, the company's services are listed vertically: 'Engineering', 'Design', 'Planning', and 'Construction Management'.

603.893.0720
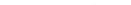
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CAFUA MANAGEMENT  
COMPANY, LLC  
280 MERRIMACK STREET  
METHUEN, MA 01844

**ASSESSORS MAP 610 BLOCK 58 LOTS 4 & 5  
477 & 479 BROADWAY  
METHUEN, MASSACHUSETTS**

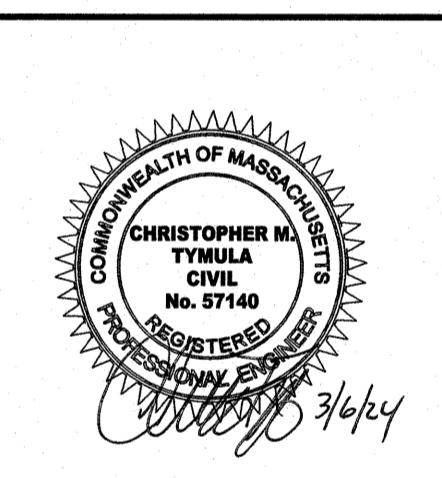


# LANDSCAPE PLAN

SCALE:  
1"=20'

9 OF 14




**FOR REGISTRY USE**

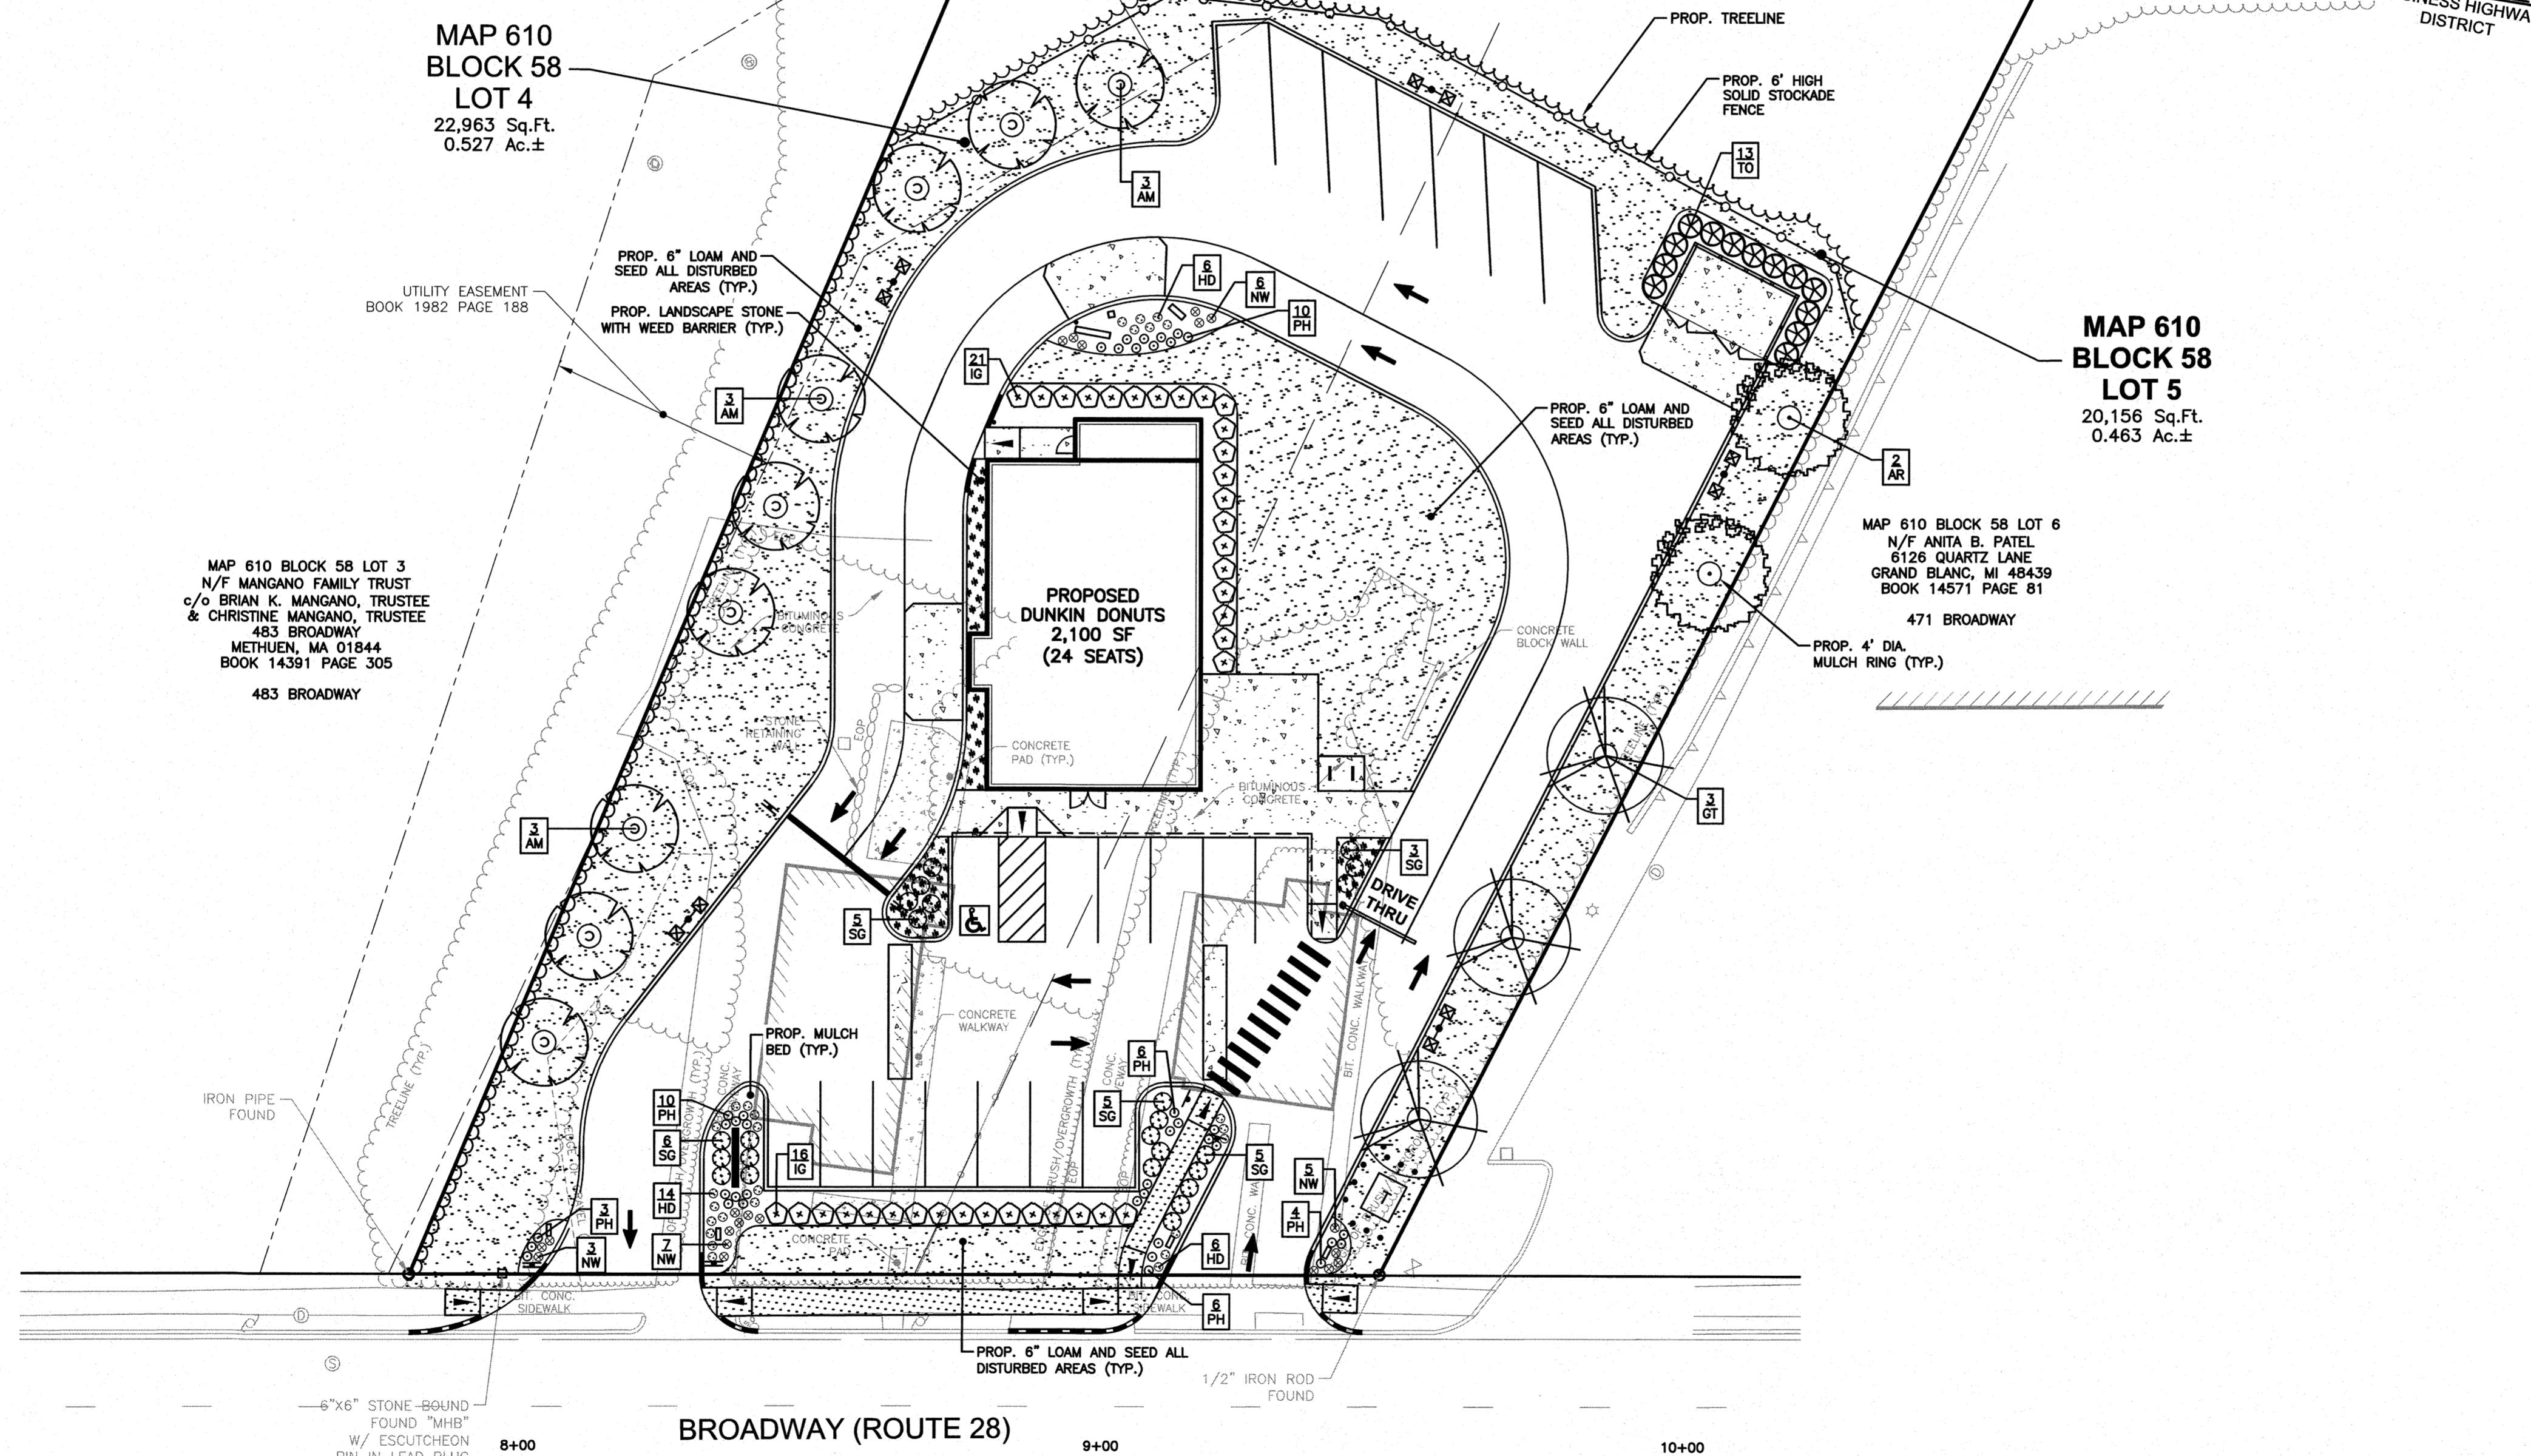

<u>APPROVED BY THE CITY OF METHUEN COMMUNITY DEVELOPMENT BOARD</u>	
<hr/> <hr/> <hr/> <hr/> <hr/>	DATE
<hr/> <hr/> <hr/> <hr/> <hr/>	FILED
<hr/> <hr/> <hr/> <hr/> <hr/>	HEARING

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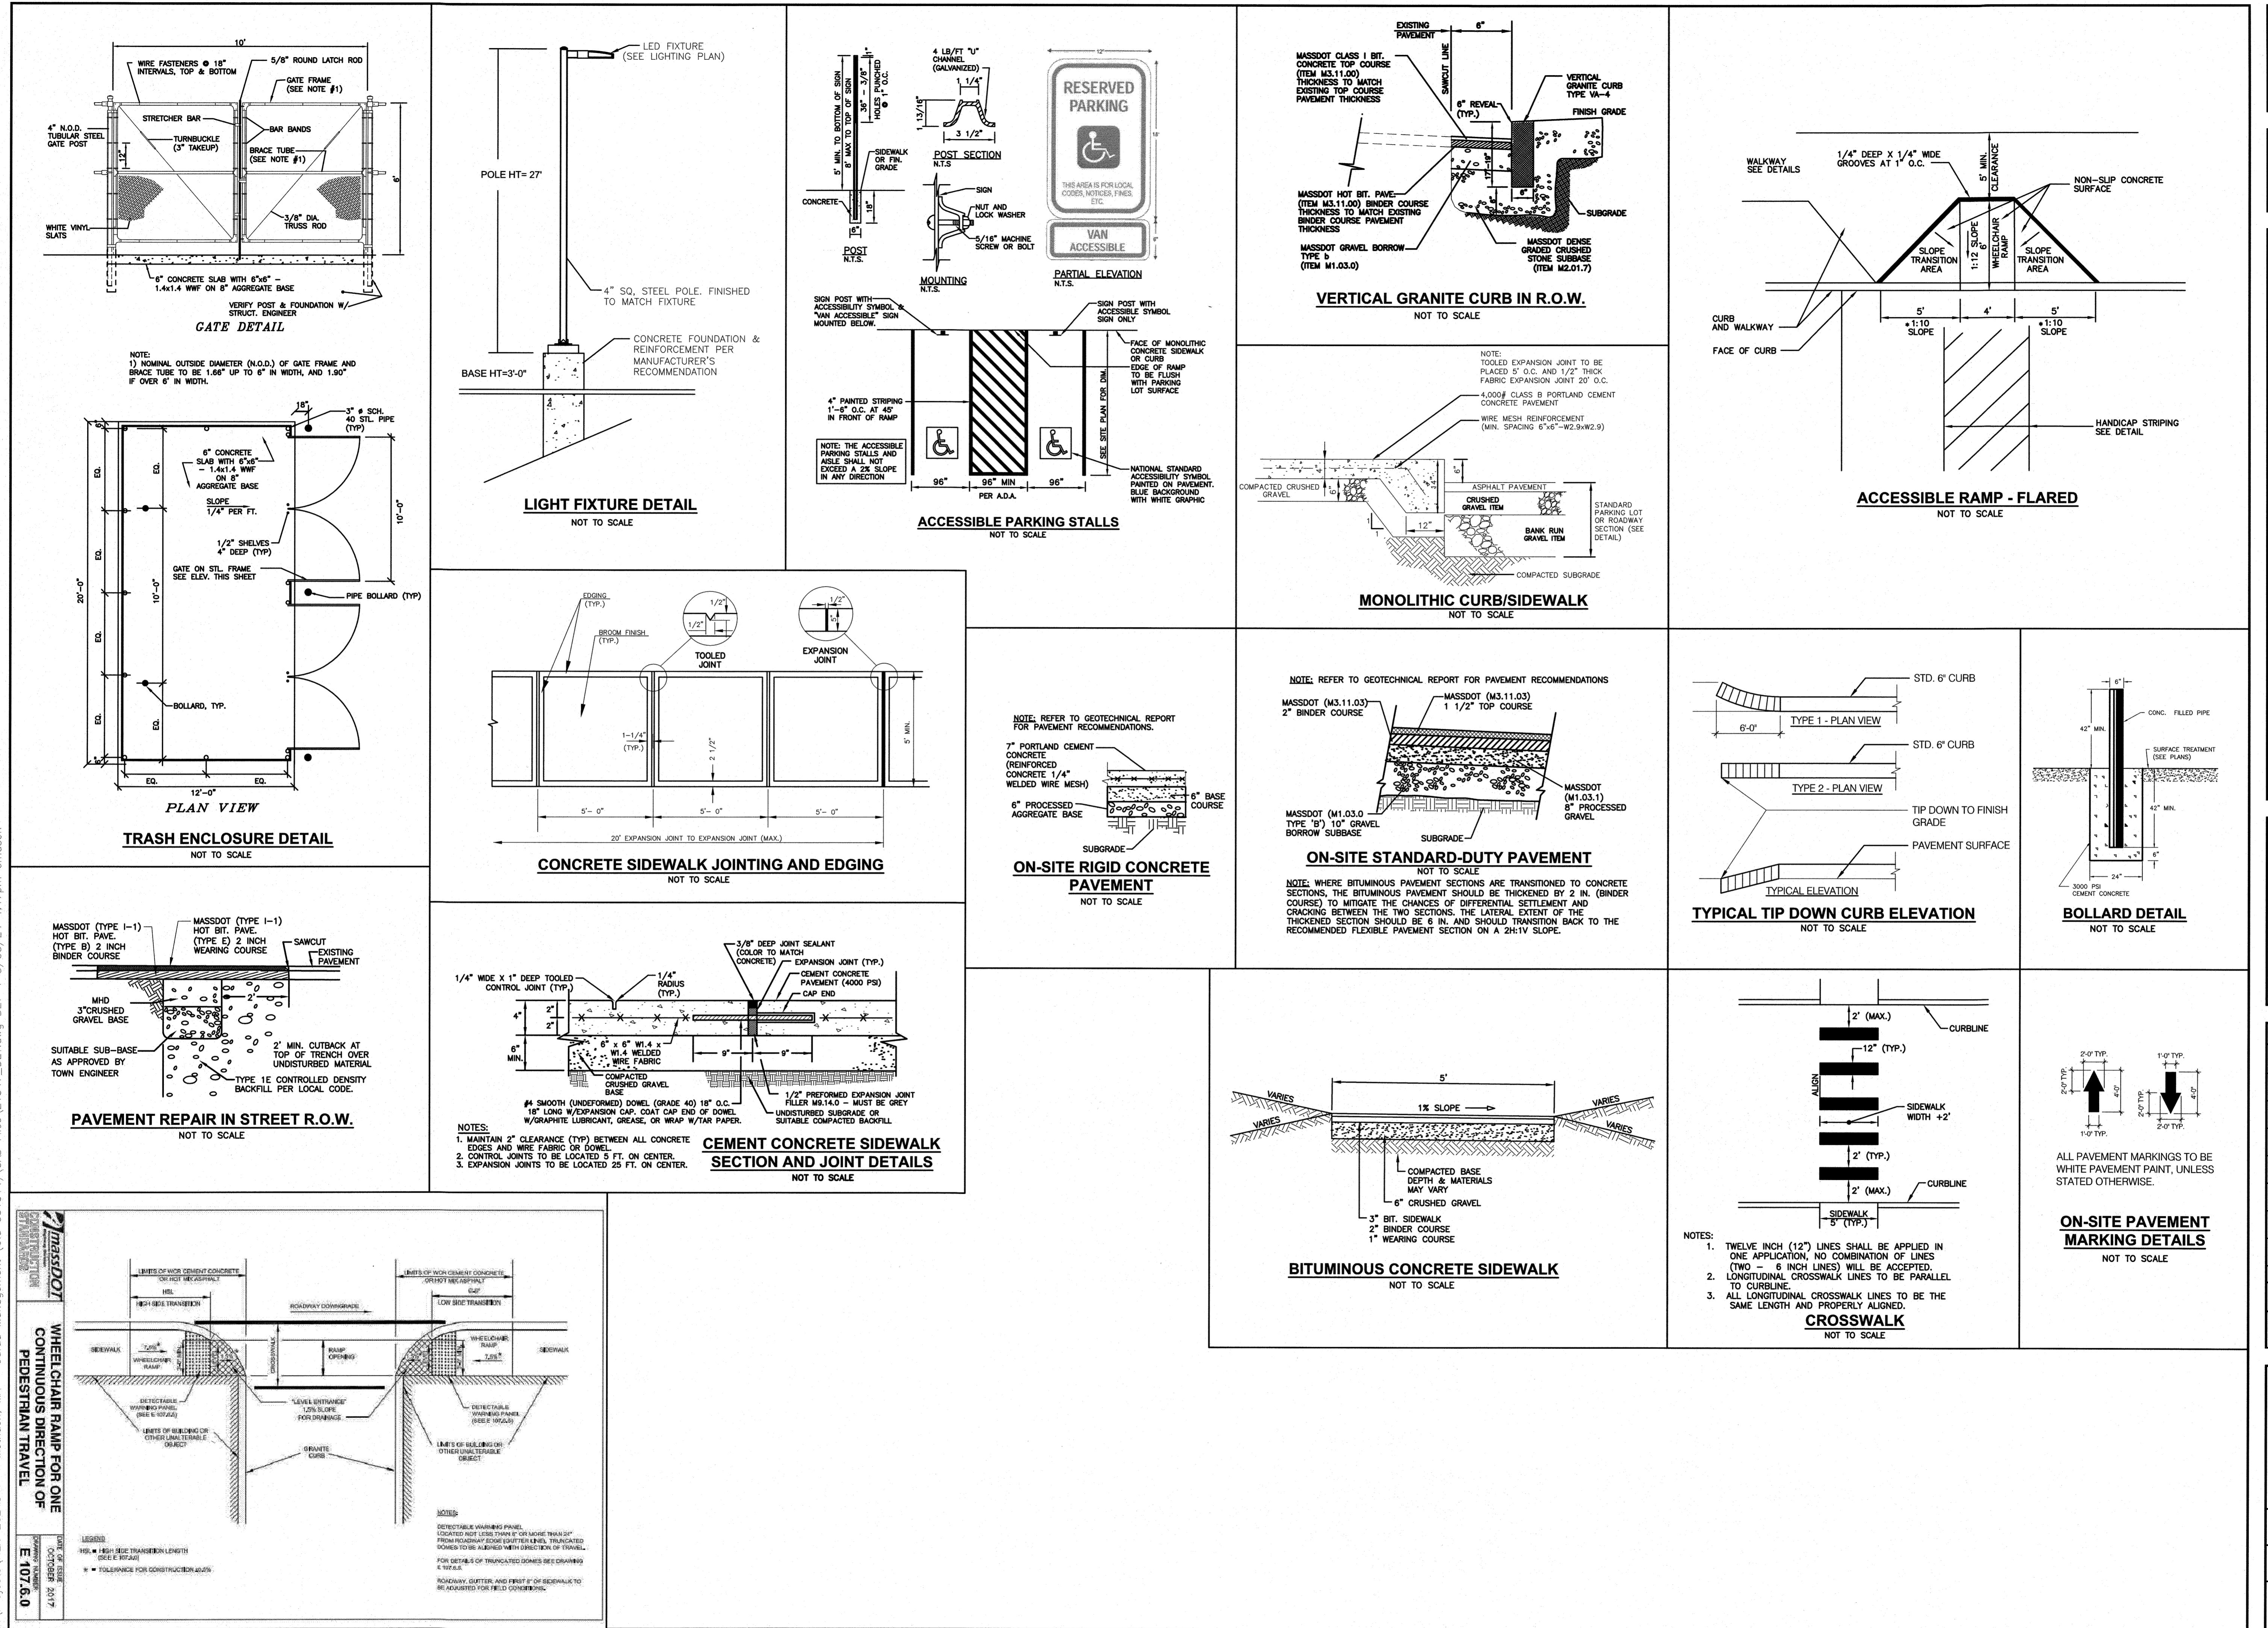
**ASSESSORS MAP 610 BLOCK 58 LOTS 4 & 5  
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METHUEN, MASSACHUSETTS**




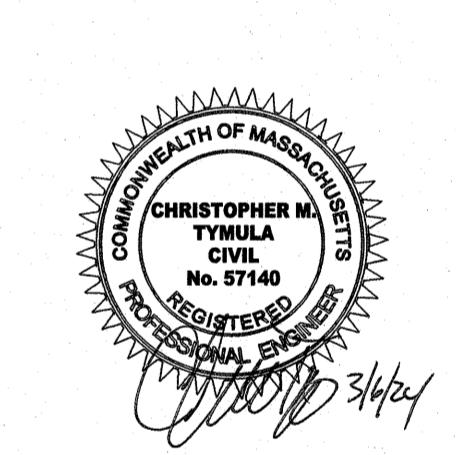


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MARCH 6, 2024  
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DETAIL SHEET		
SCALE: NOT TO SCALE		
PROJECT NO. NEX-2021347		






NO.	REVISION	DATE
	MARCH 6, 2024	
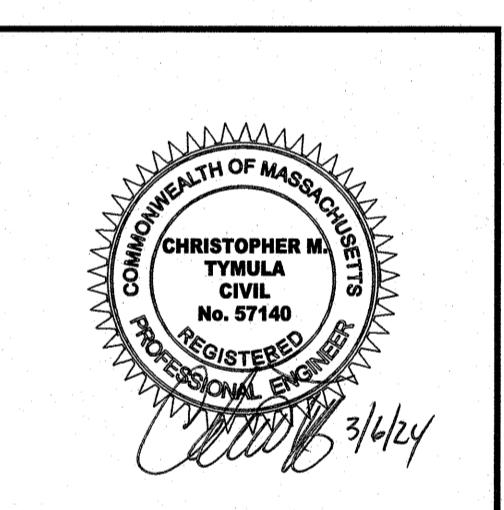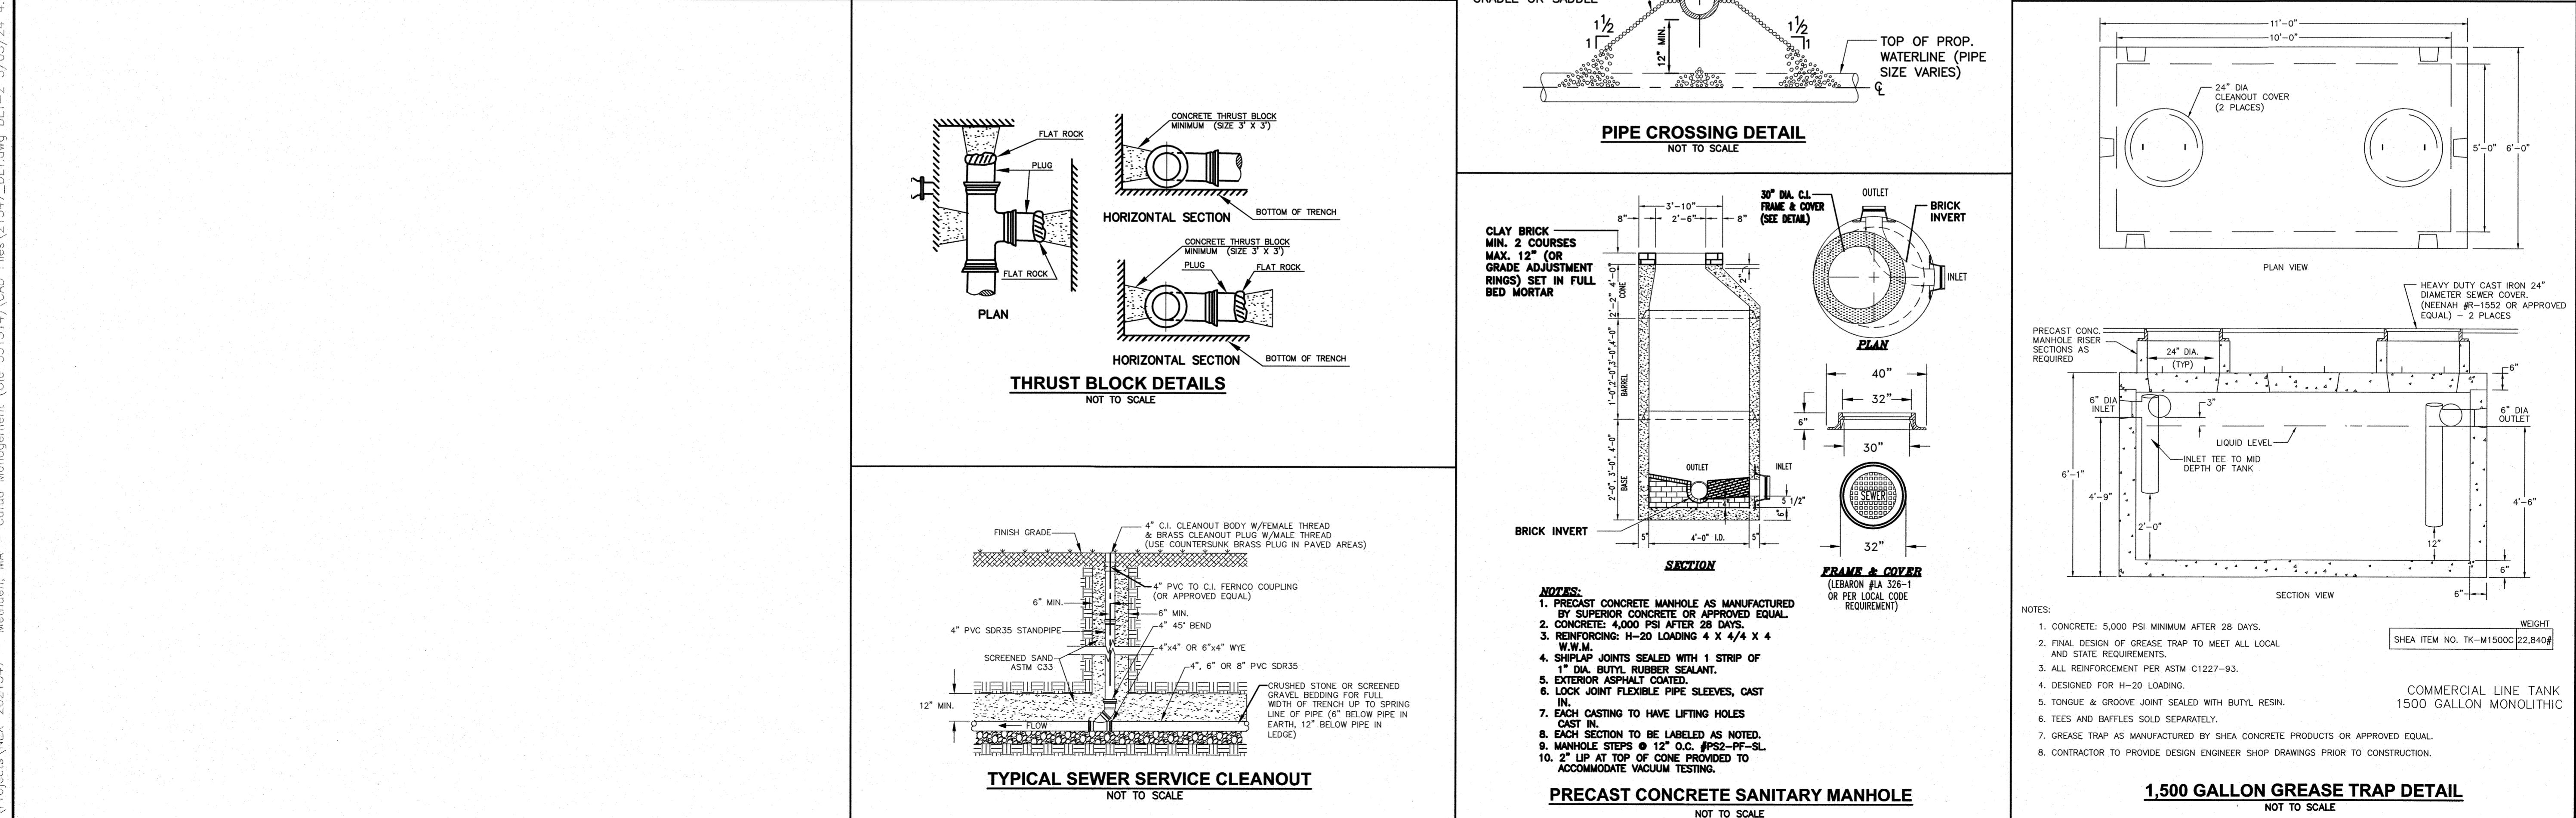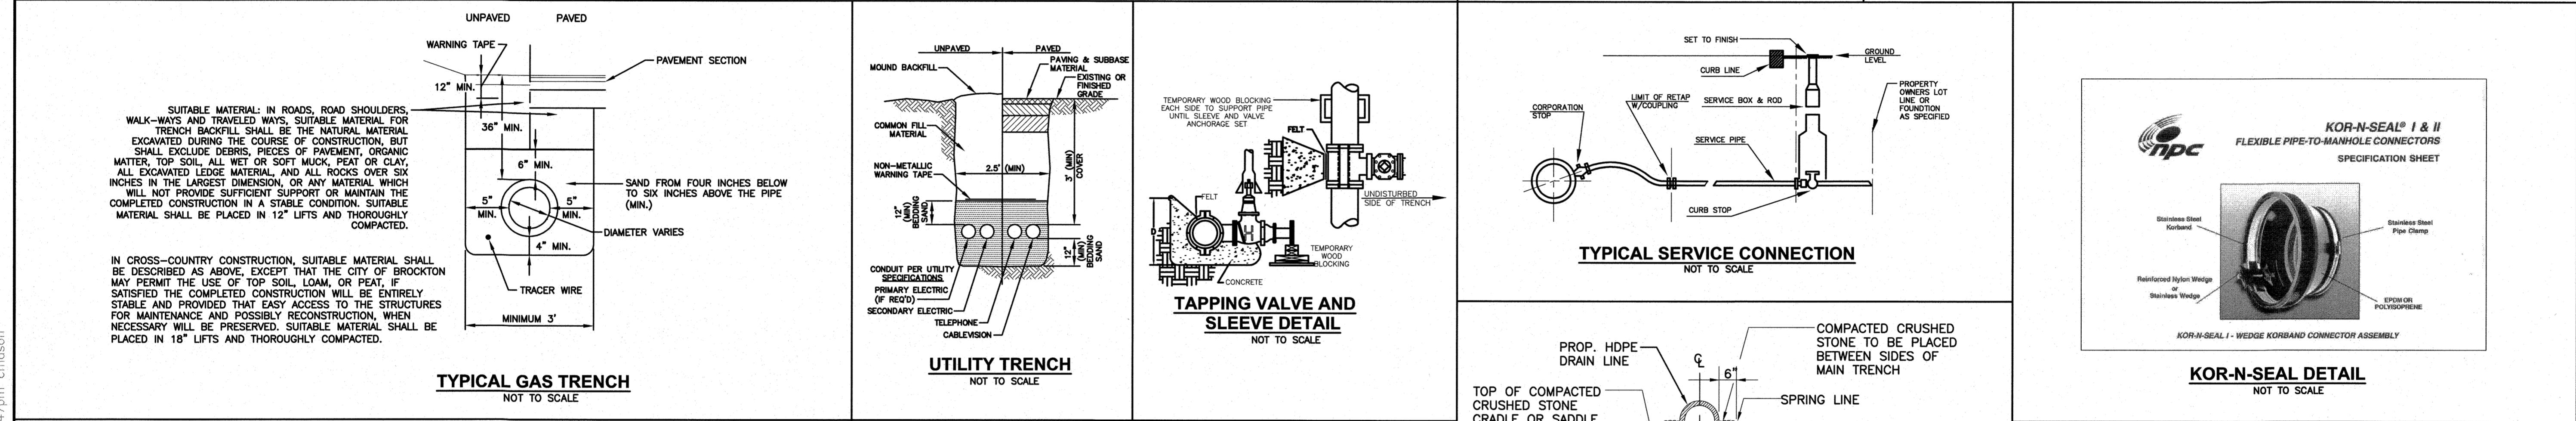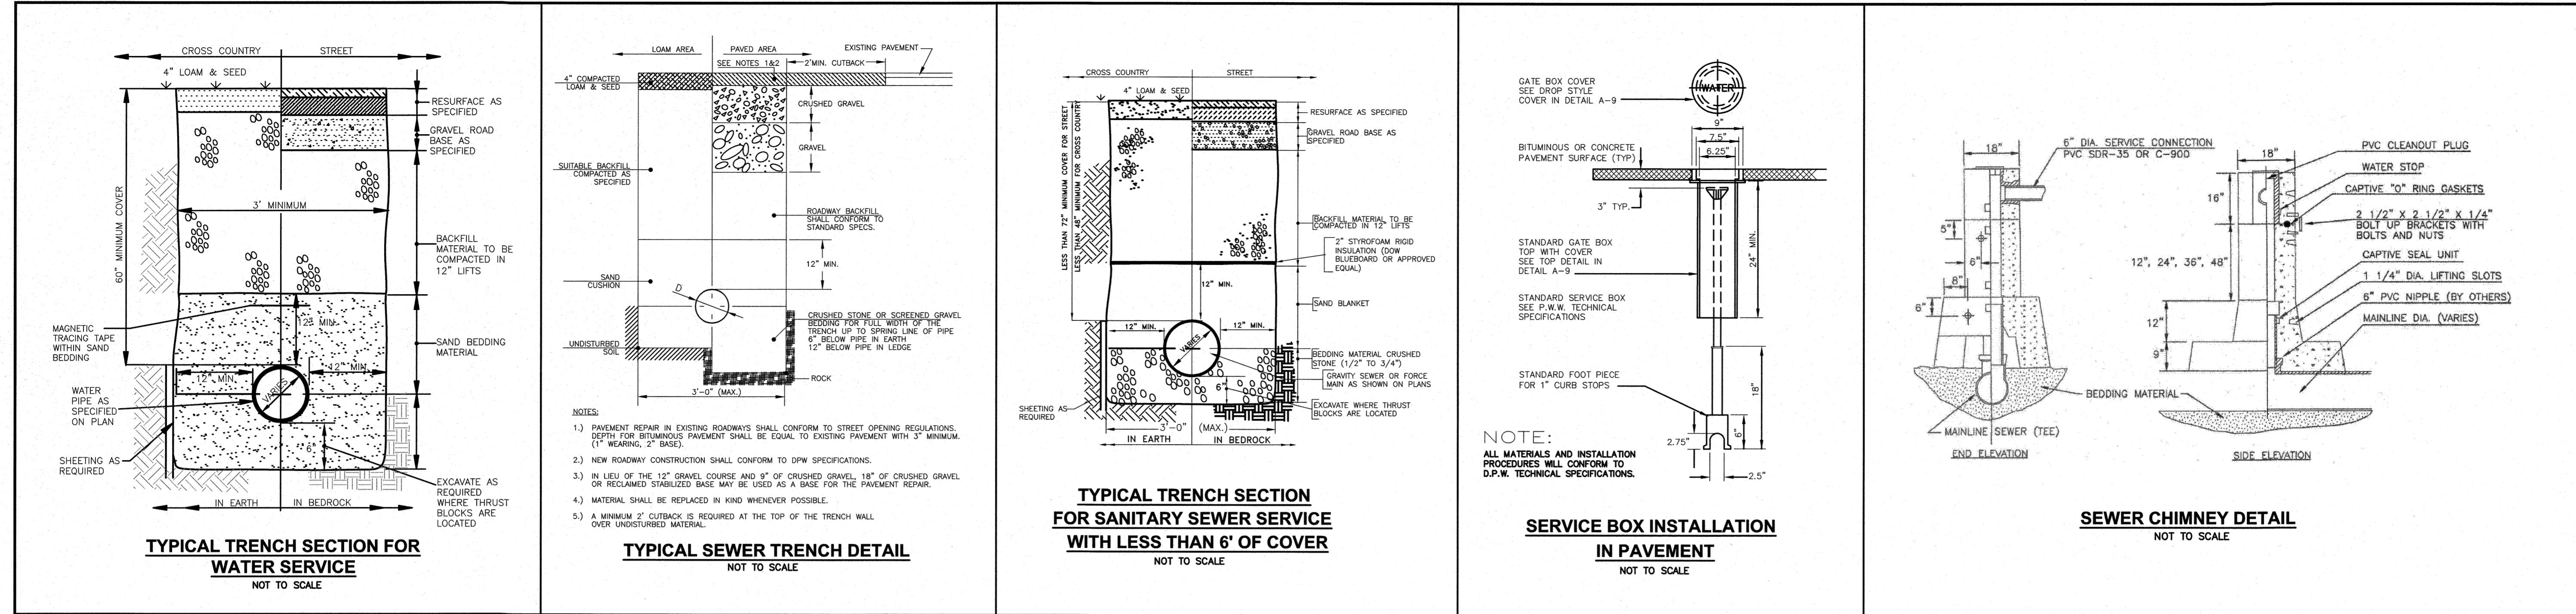
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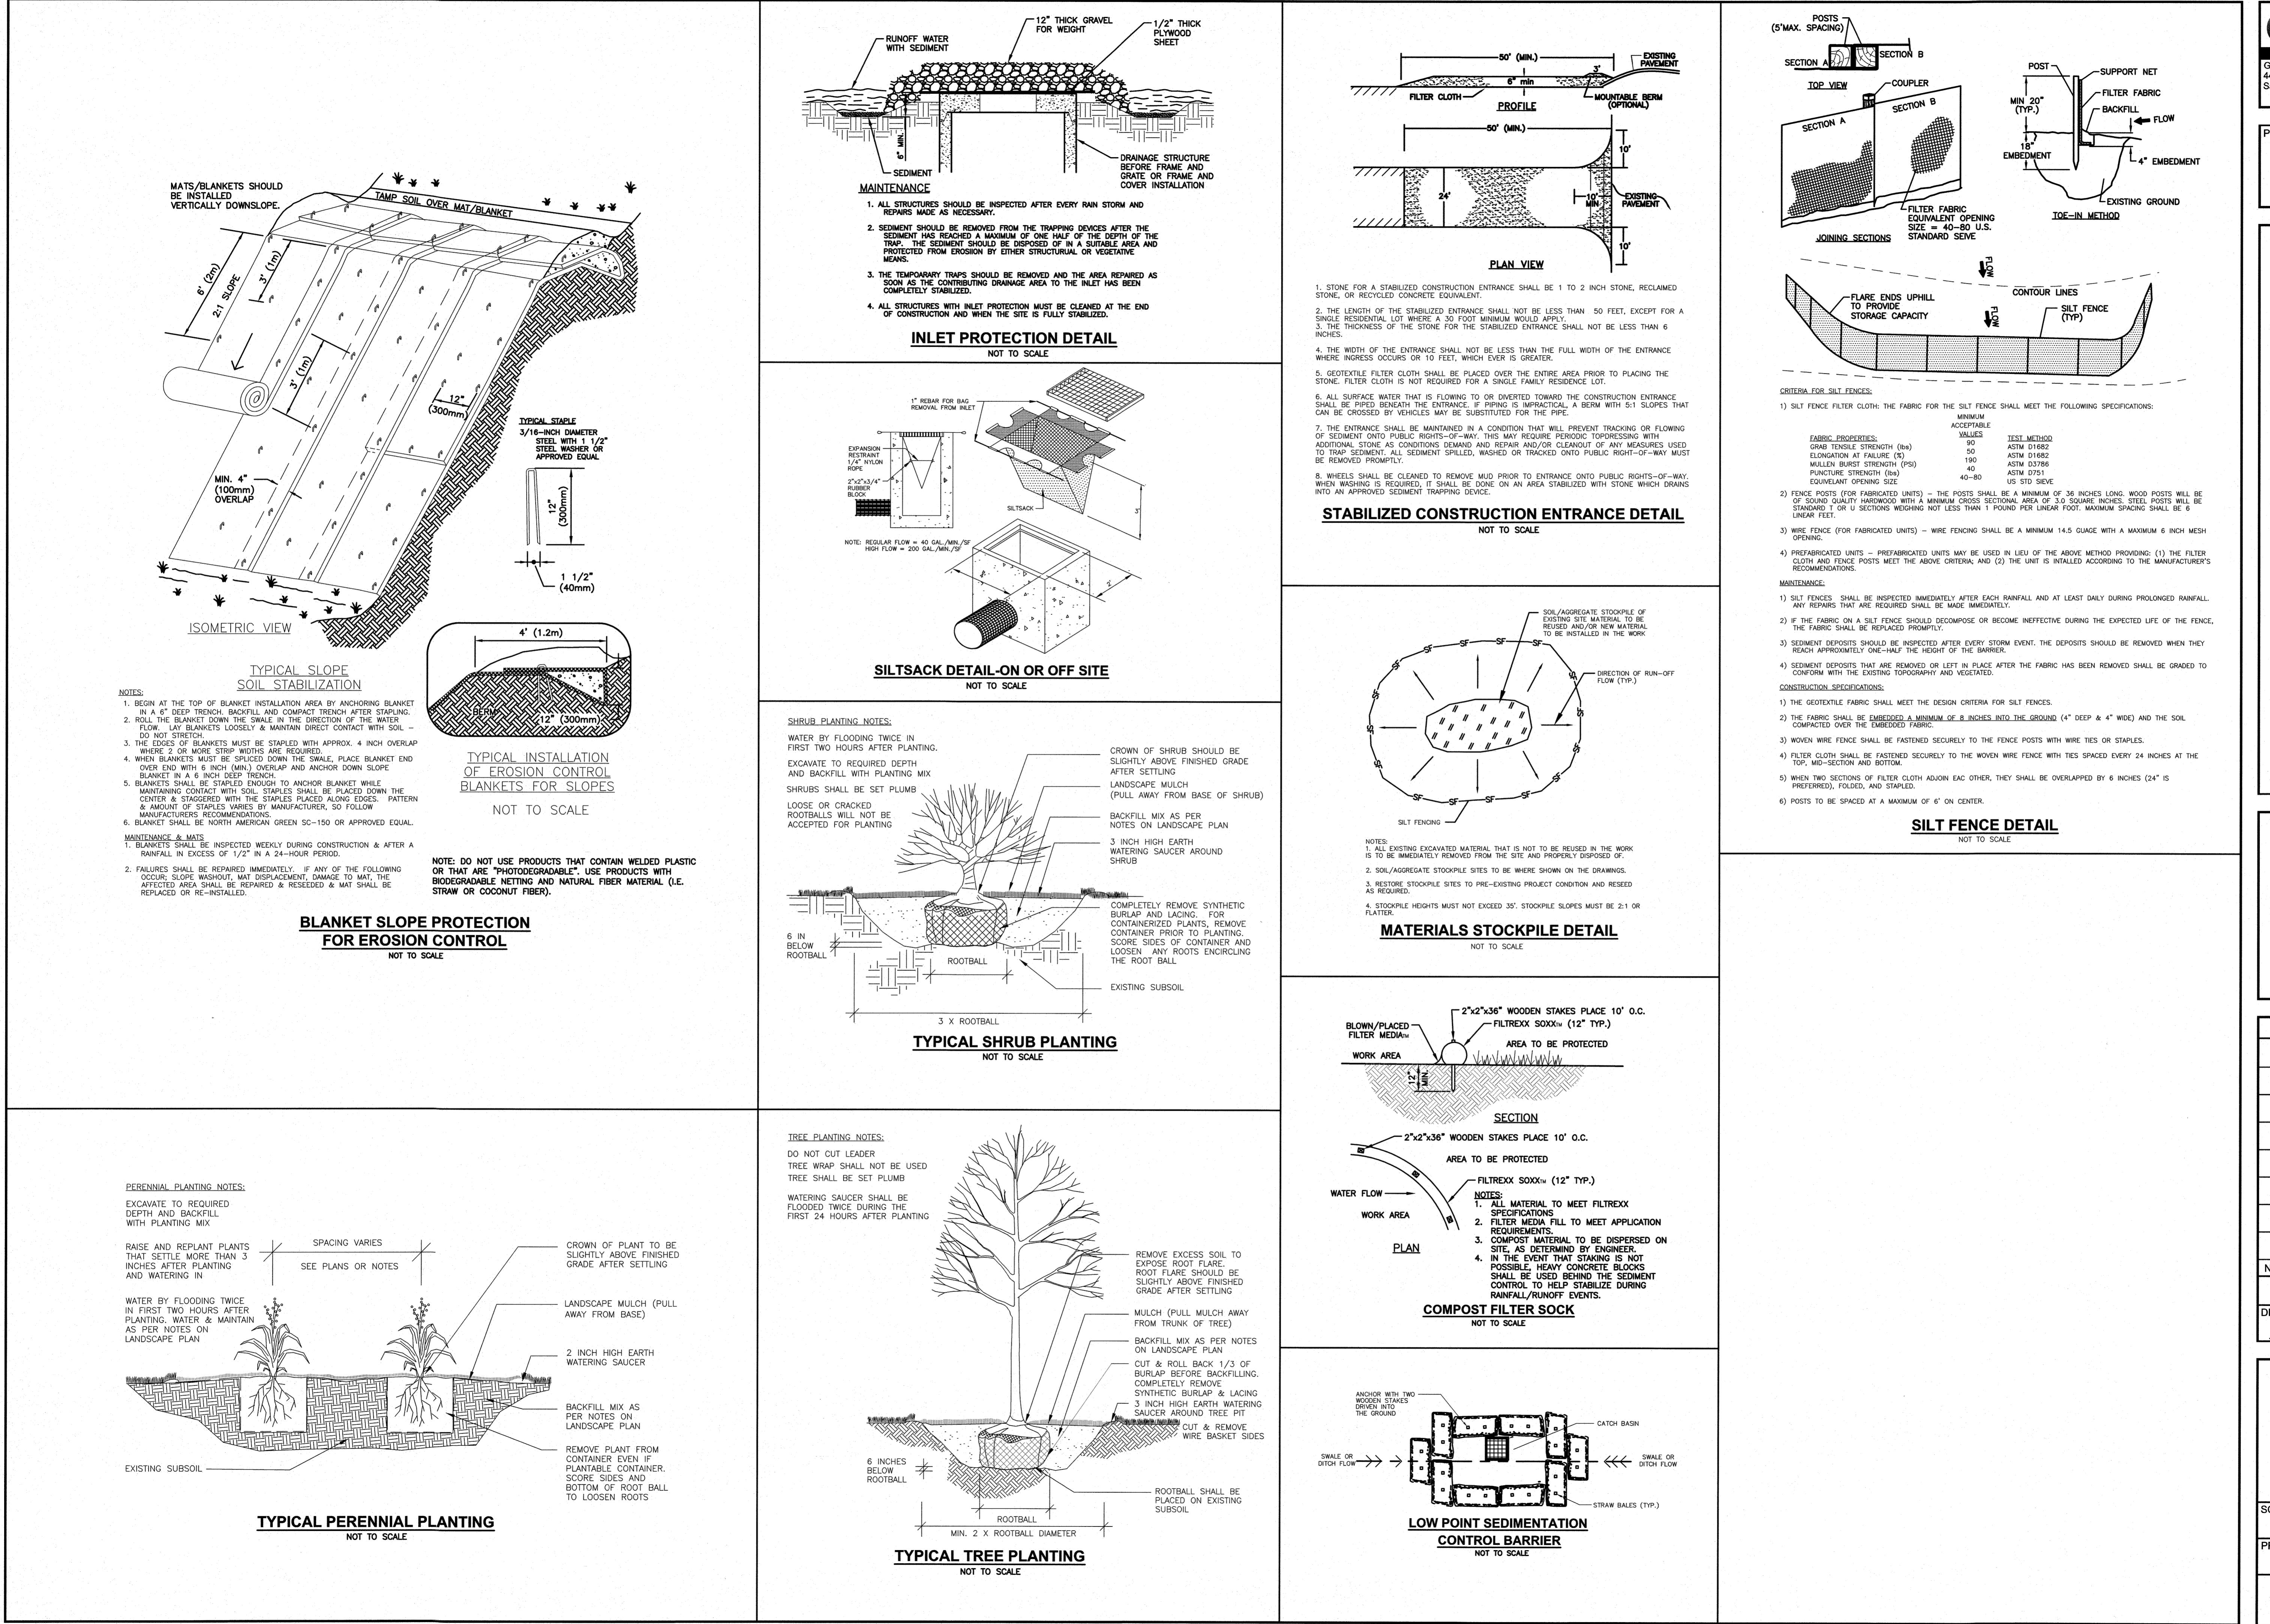
DETAIL SHEET	
SCALE: NOT TO SCALE	PROJECT NO. NEX-2021347

**ASSESSORS MAP 610 BLOCK 58 LOTS 4 & 5  
477 & 479 BROADWAY  
METHUEN, MASSACHUSETTS**

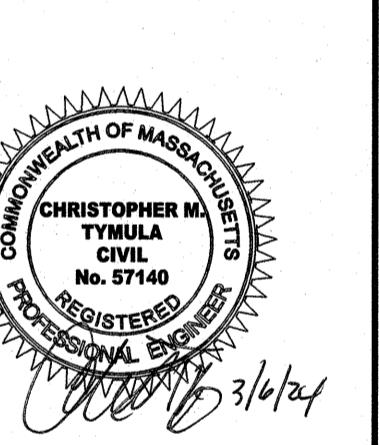

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MARCH 6, 2024		
DRAWN/DESIGN BY	CHECKED BY	
SJB/CMT	CMT	

DETAIL SHEET	
SCALE:	NOT TO SCALE
PROJECT NO.	NEX-2021347









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280 MERRIMACK STREET  
METHUEN, MA 01844


**ASSESSORS MAP 610 BLOCK 58 LOTS 4 & 5  
477 & 479 BROADWAY  
METHUEN, MASSACHUSETTS**

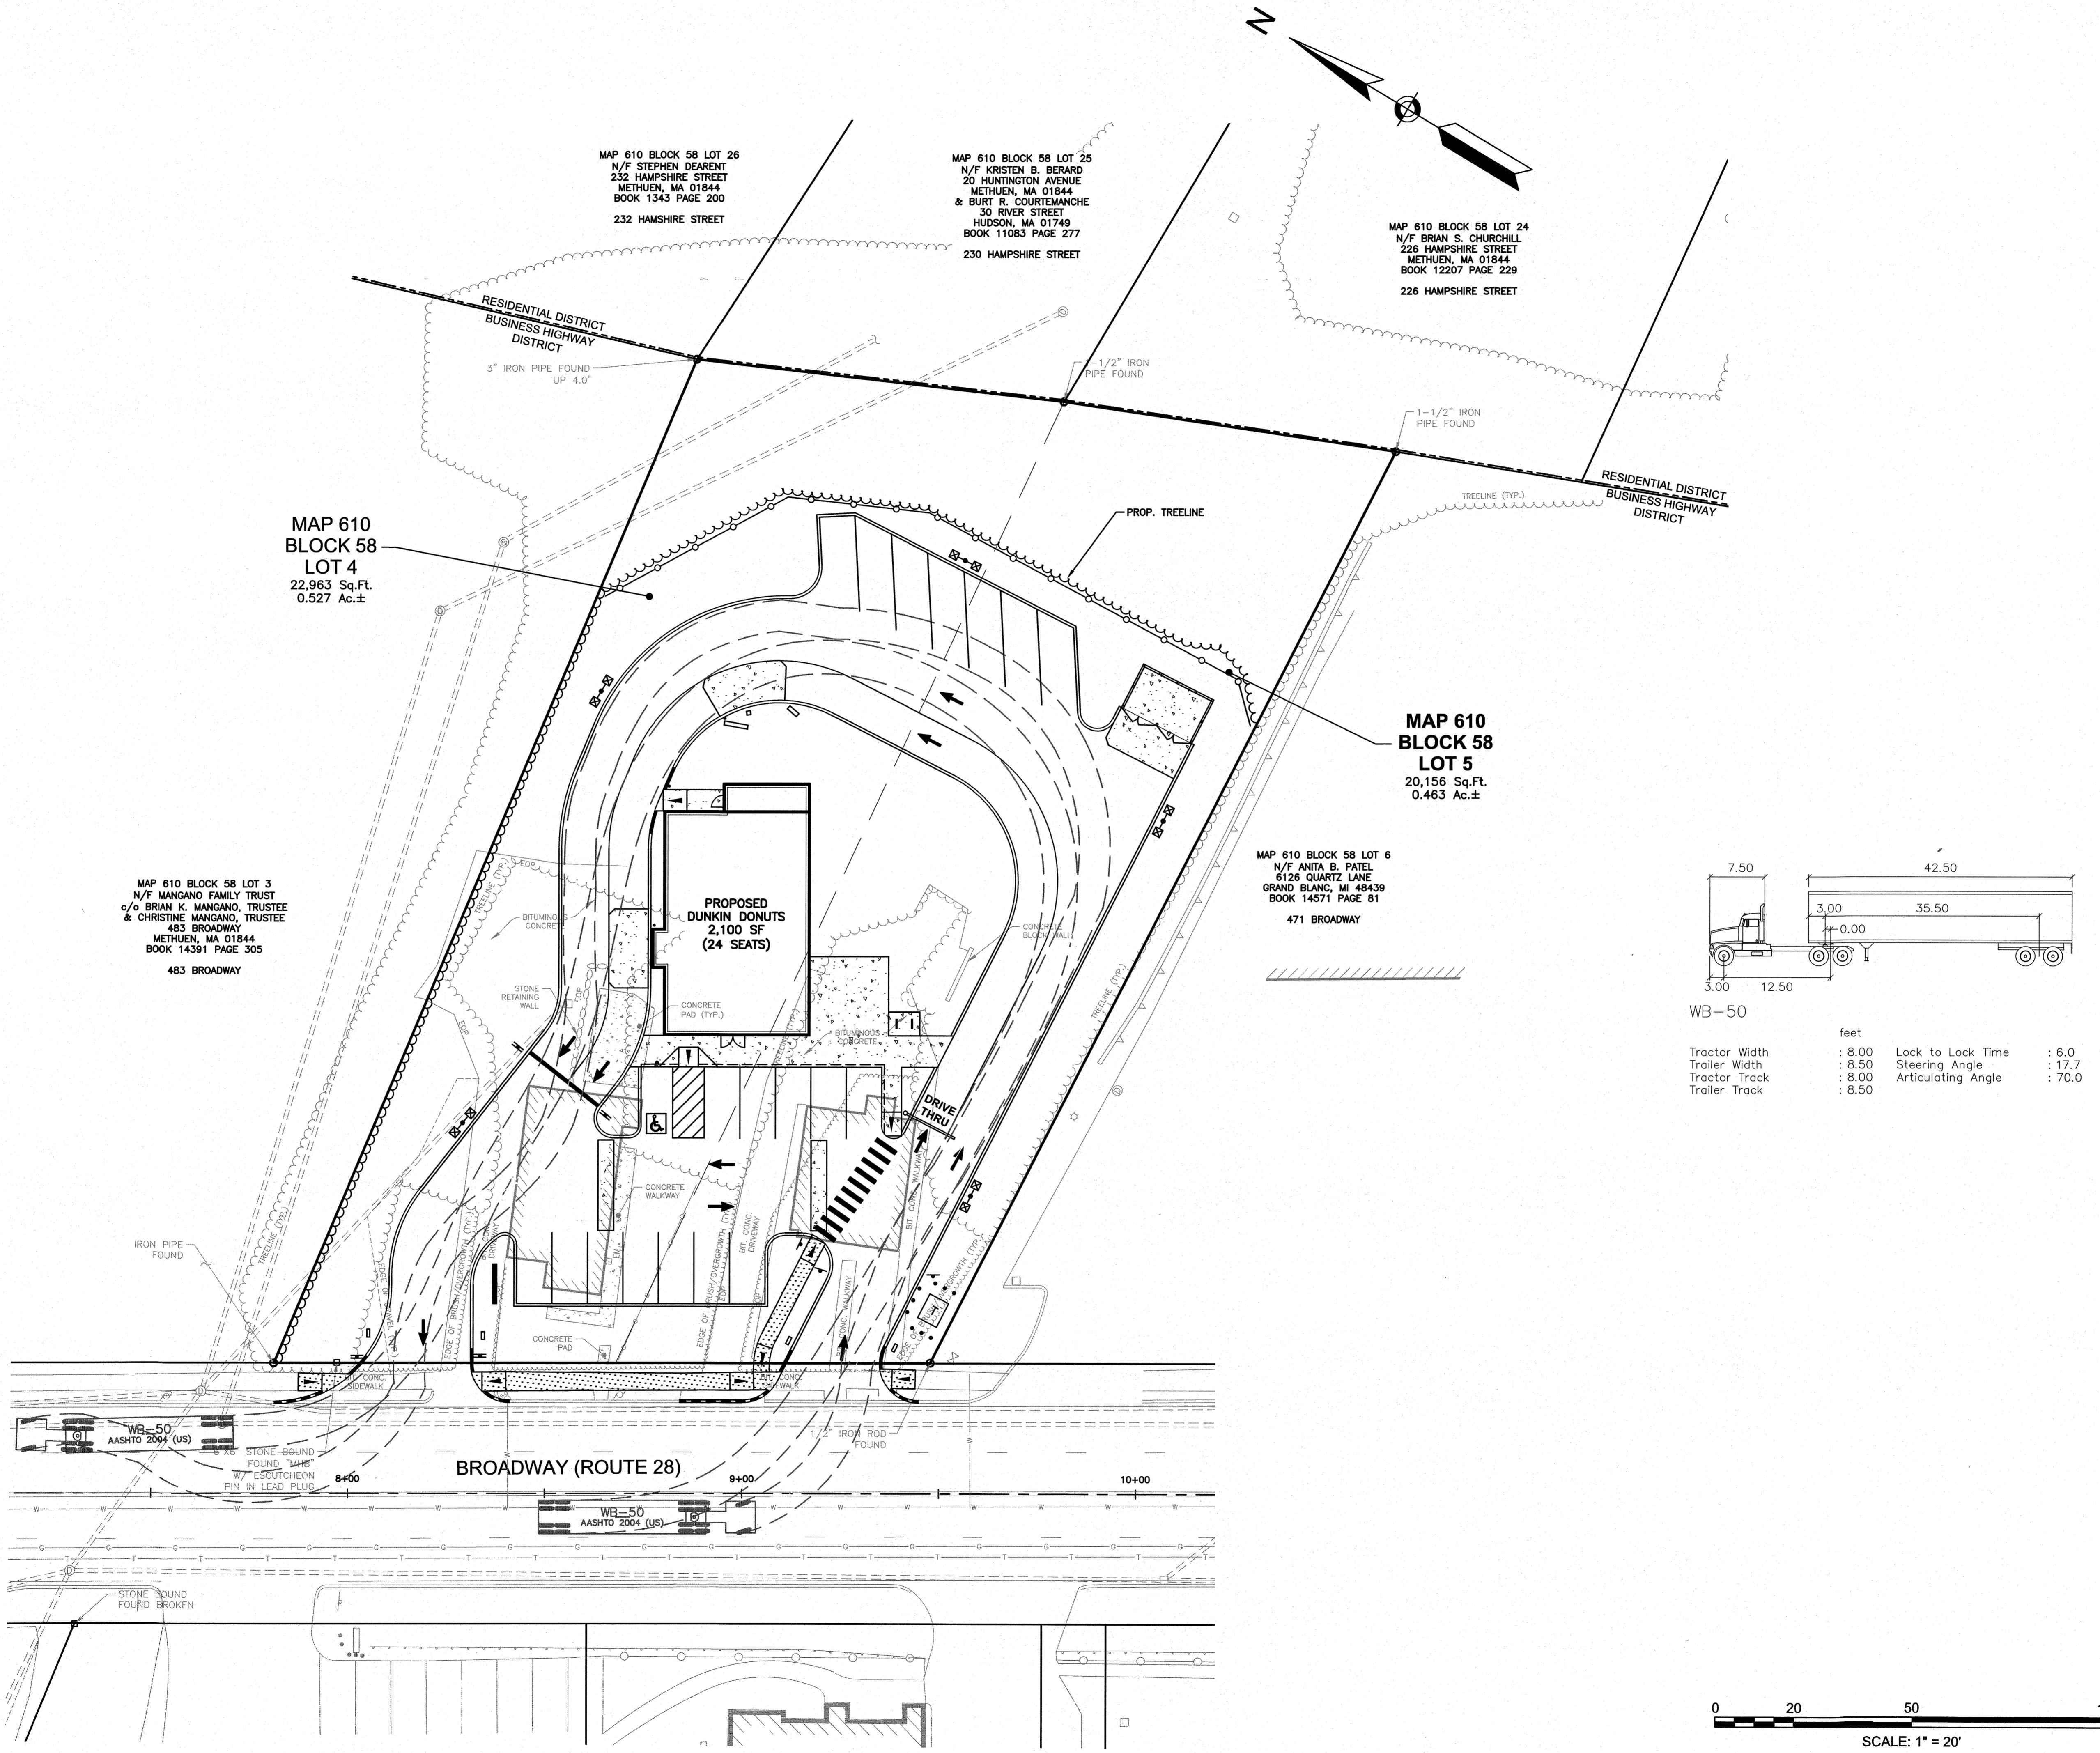

**TRUCK TURN  
PLAN**

SCALE: 1"=20'  
PROJECT NO.  
NEX-2021347  
1 OF 1

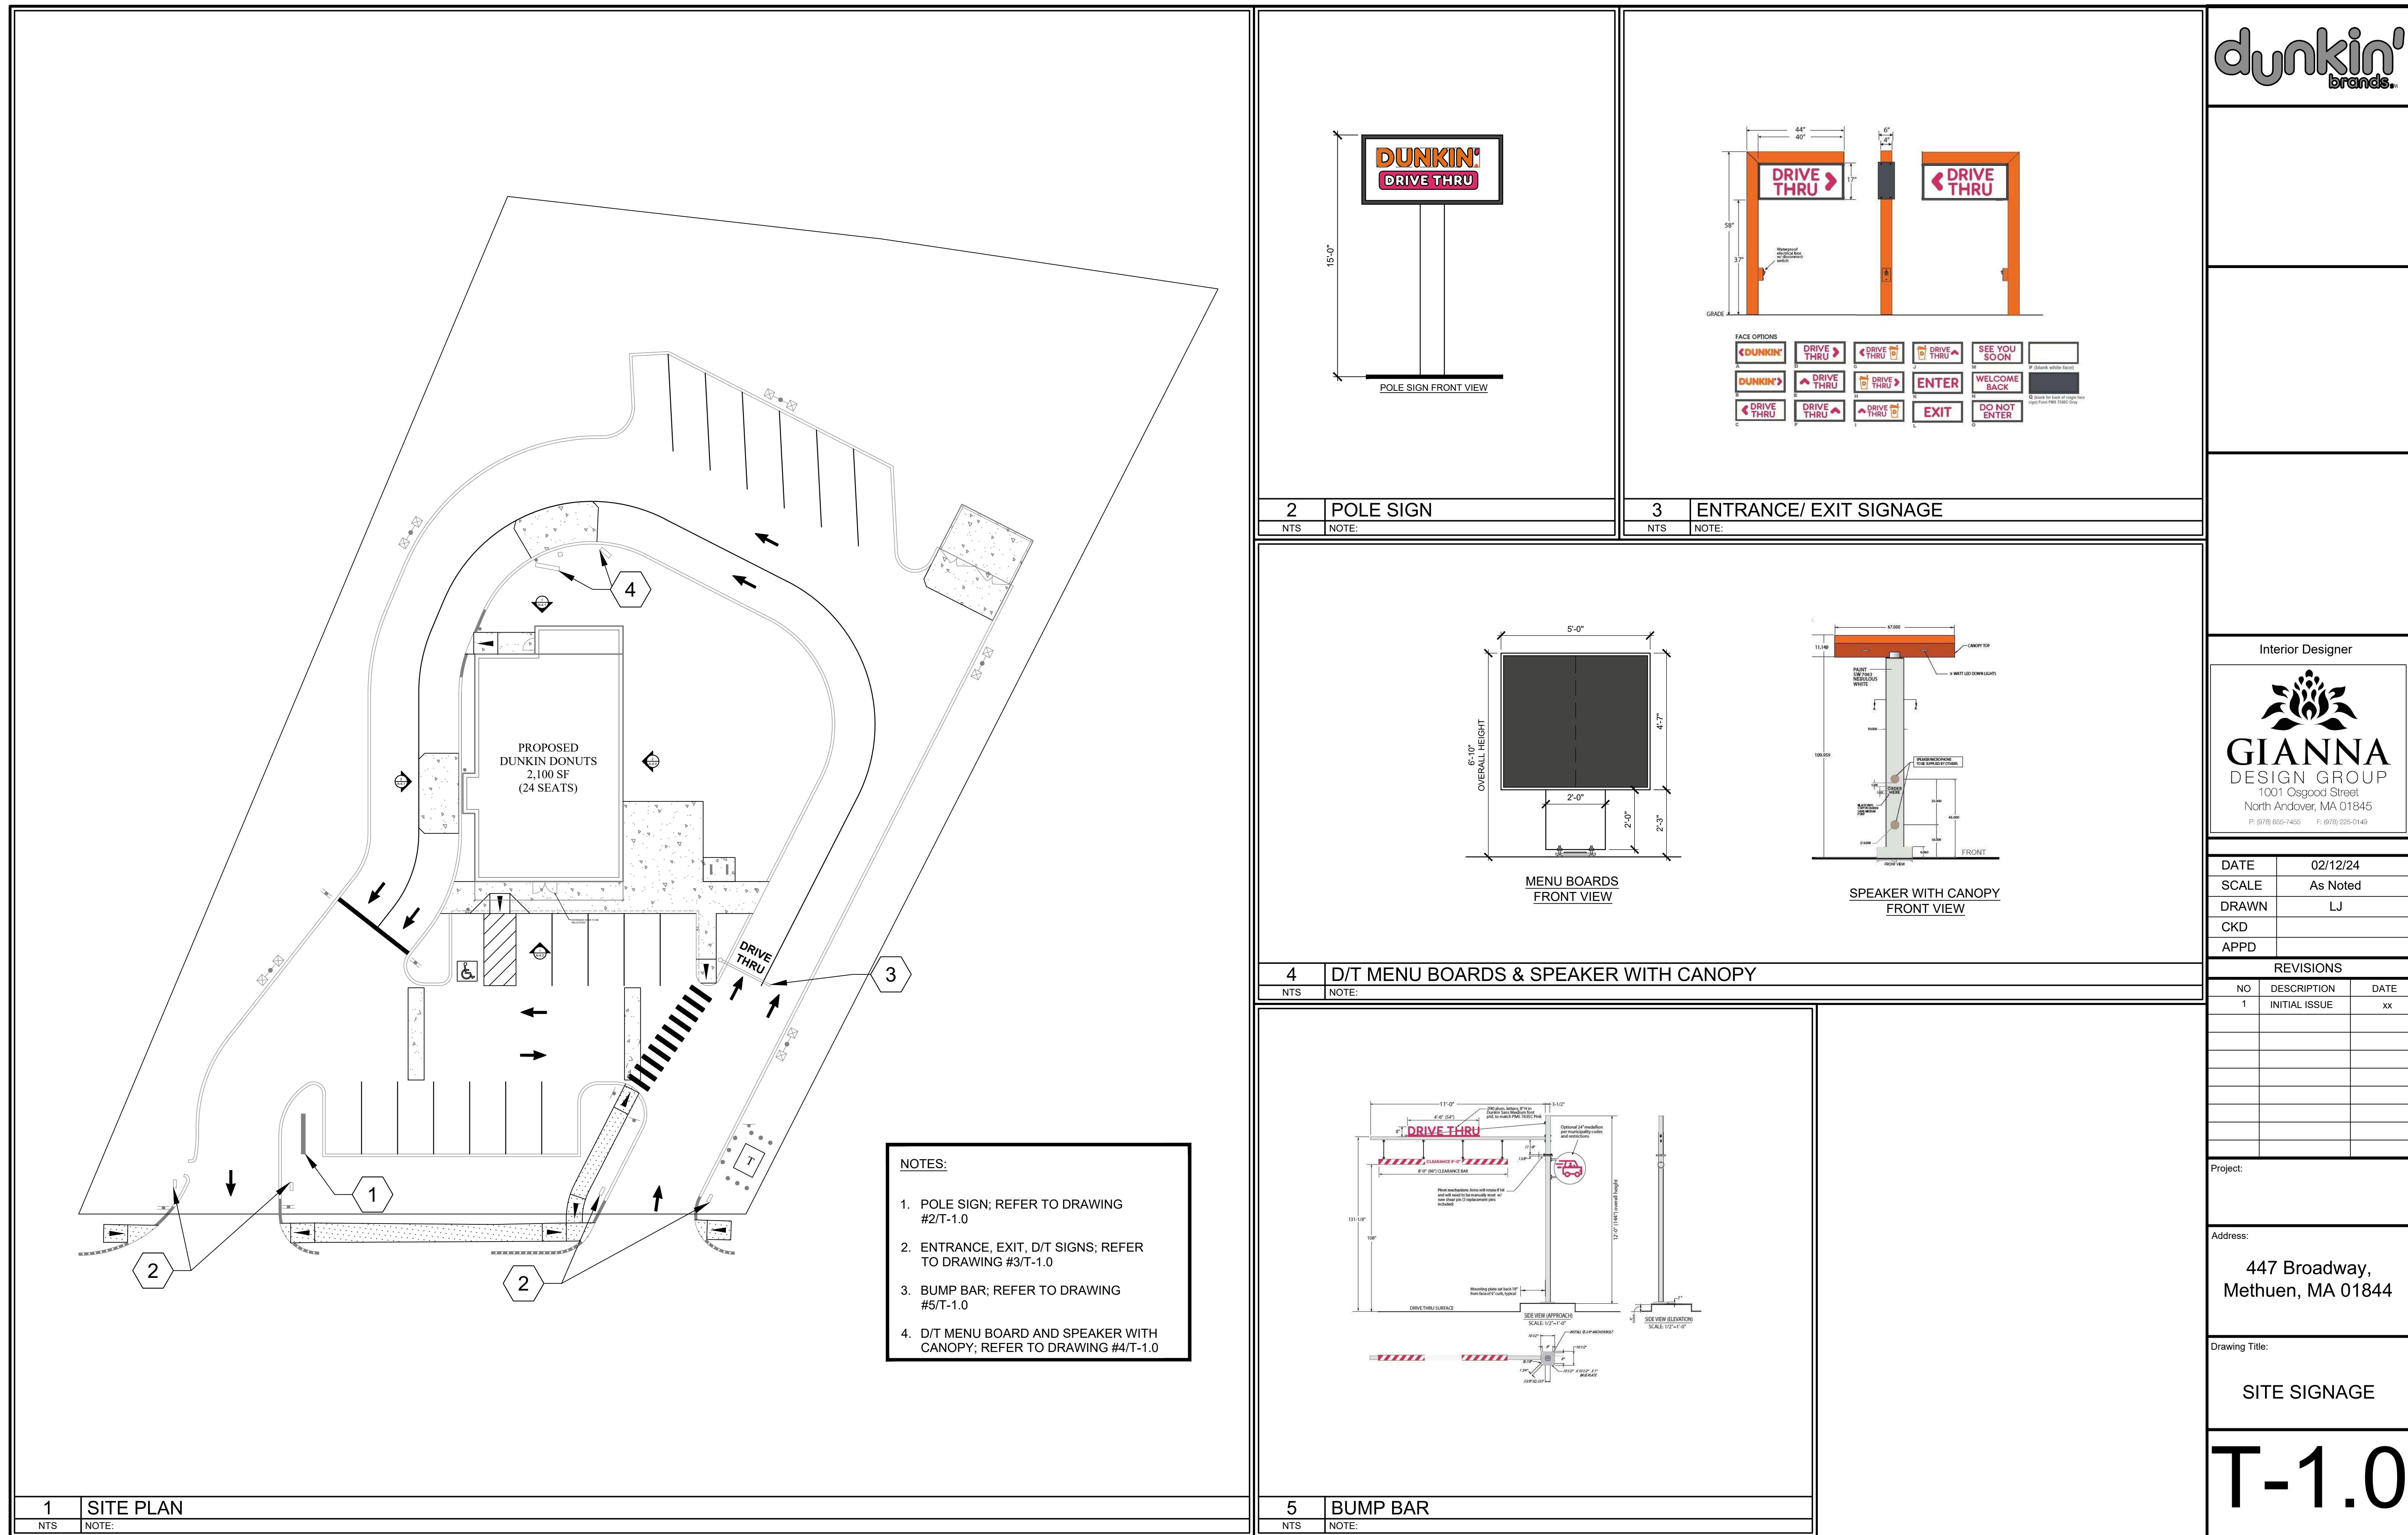

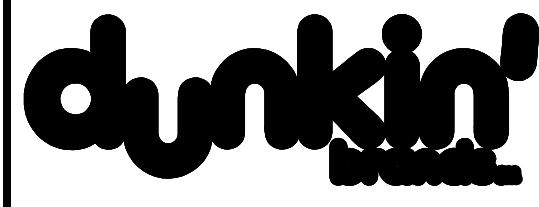

Stamp:

## Consulting Architect

## Interior Designer



# GIANNA DESIGN GROUP

1001 Osgood Street  
North Andover, MA 01845  
P: (978) 655-7155 E: (978) 225-0149

DATE | 02/12/24

CALE As Noted

AS Noted

KWW

PPD

## REVISIONS

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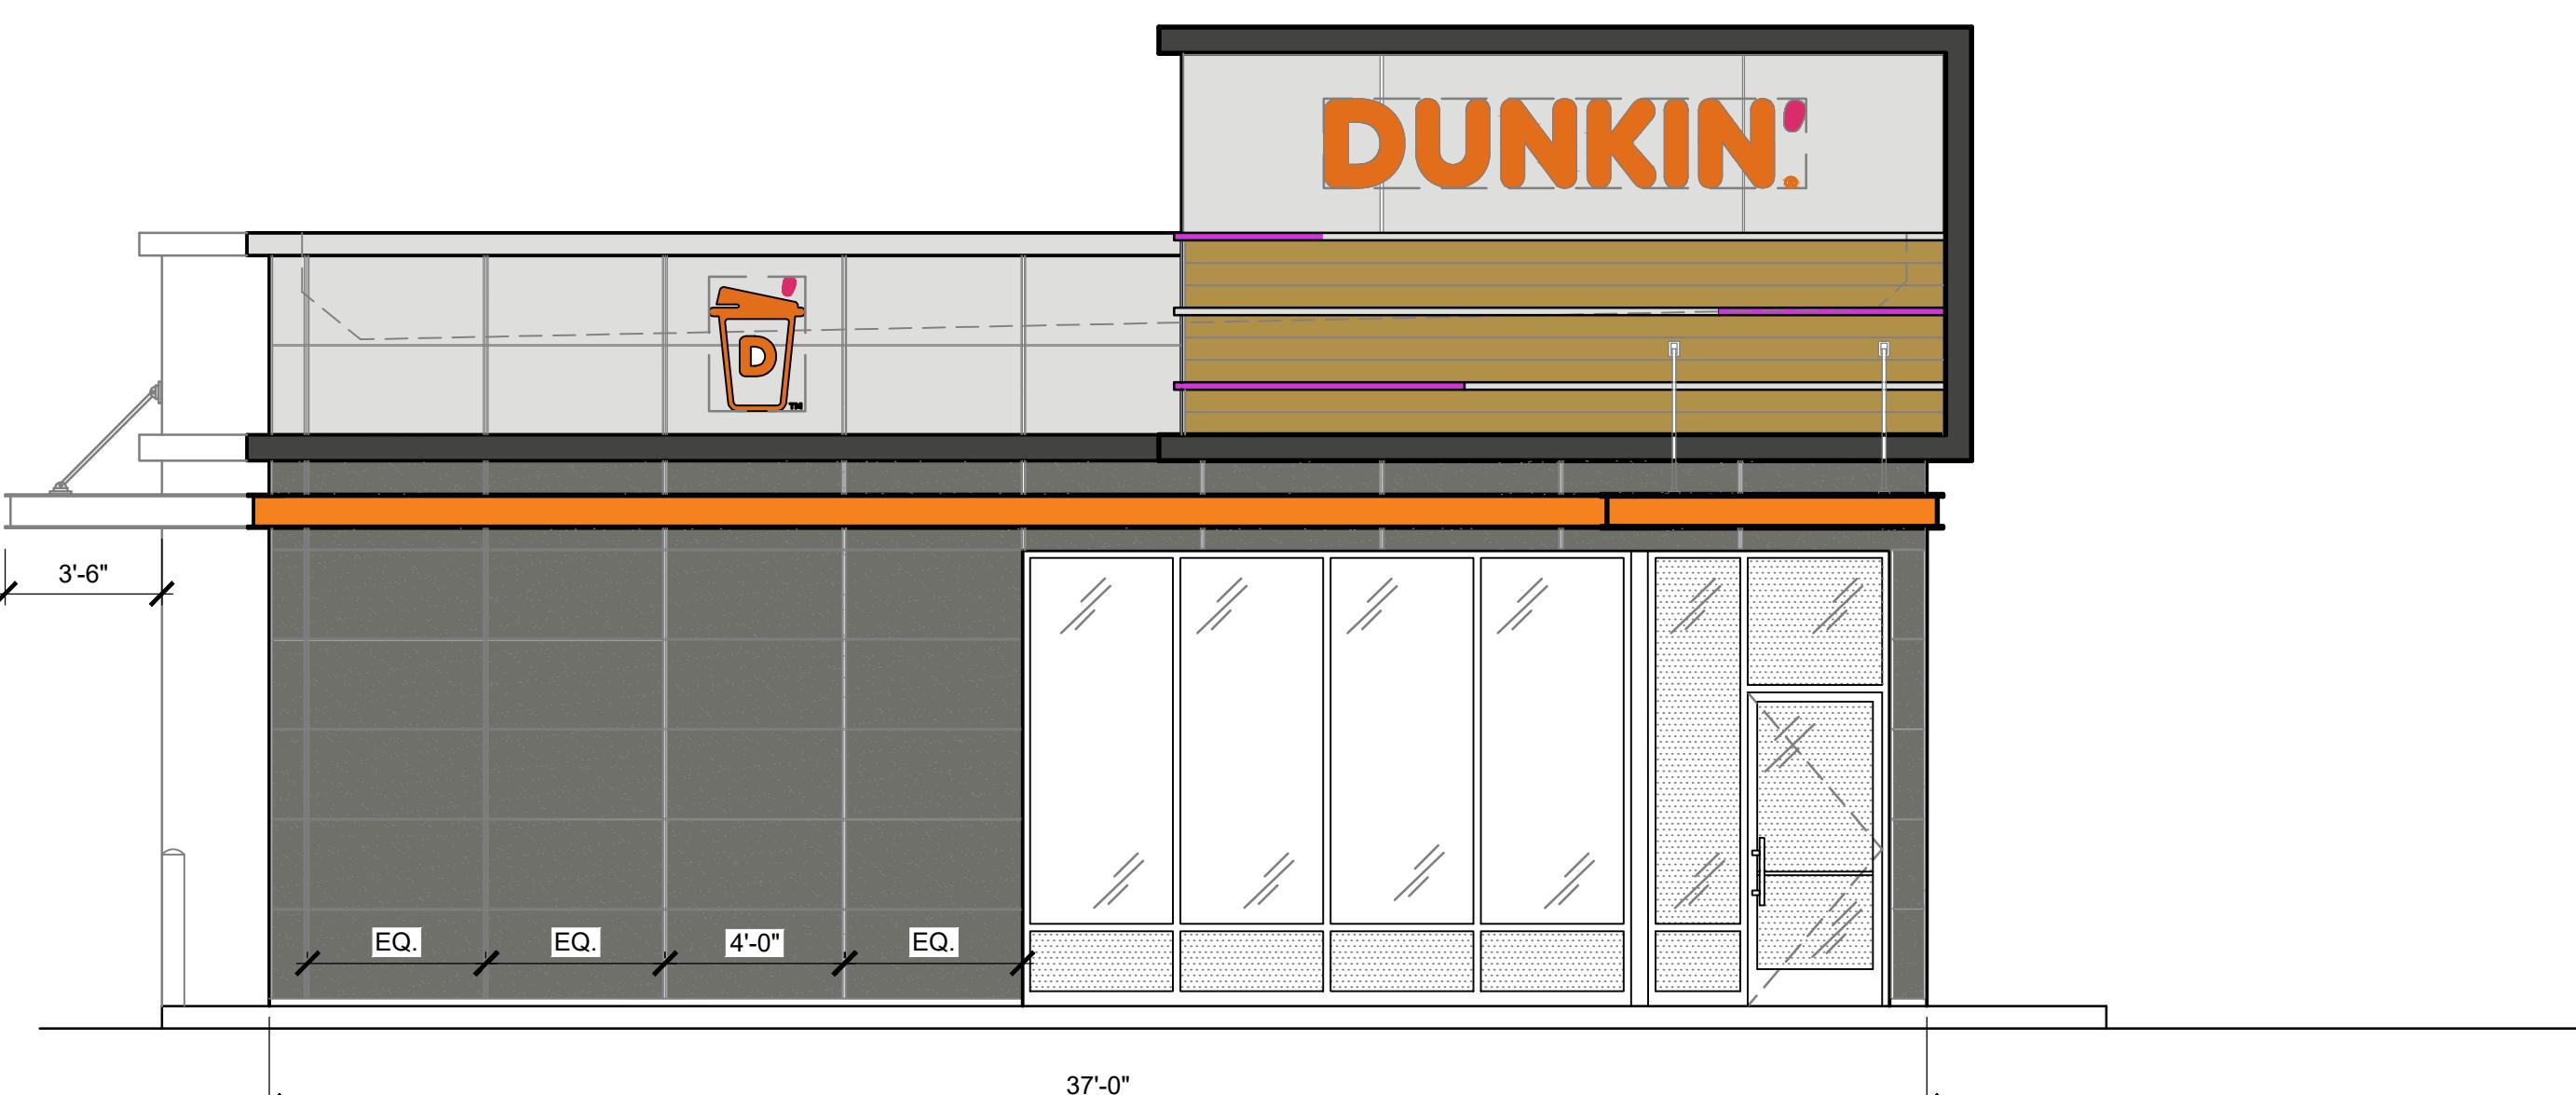
ss:  
447 Broadway,  
Methuen, MA 01844

11. **What is the primary purpose of the *Journal of Clinical Endocrinology and Metabolism*?**

## EXTERIOR ELEVATIONS


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## 1 FRONT ELEVATION

1/4" = 1'-0" | NOTE:



## 2 | RIGHT ELEVATION

1/4" = 1'-0" NOTE:

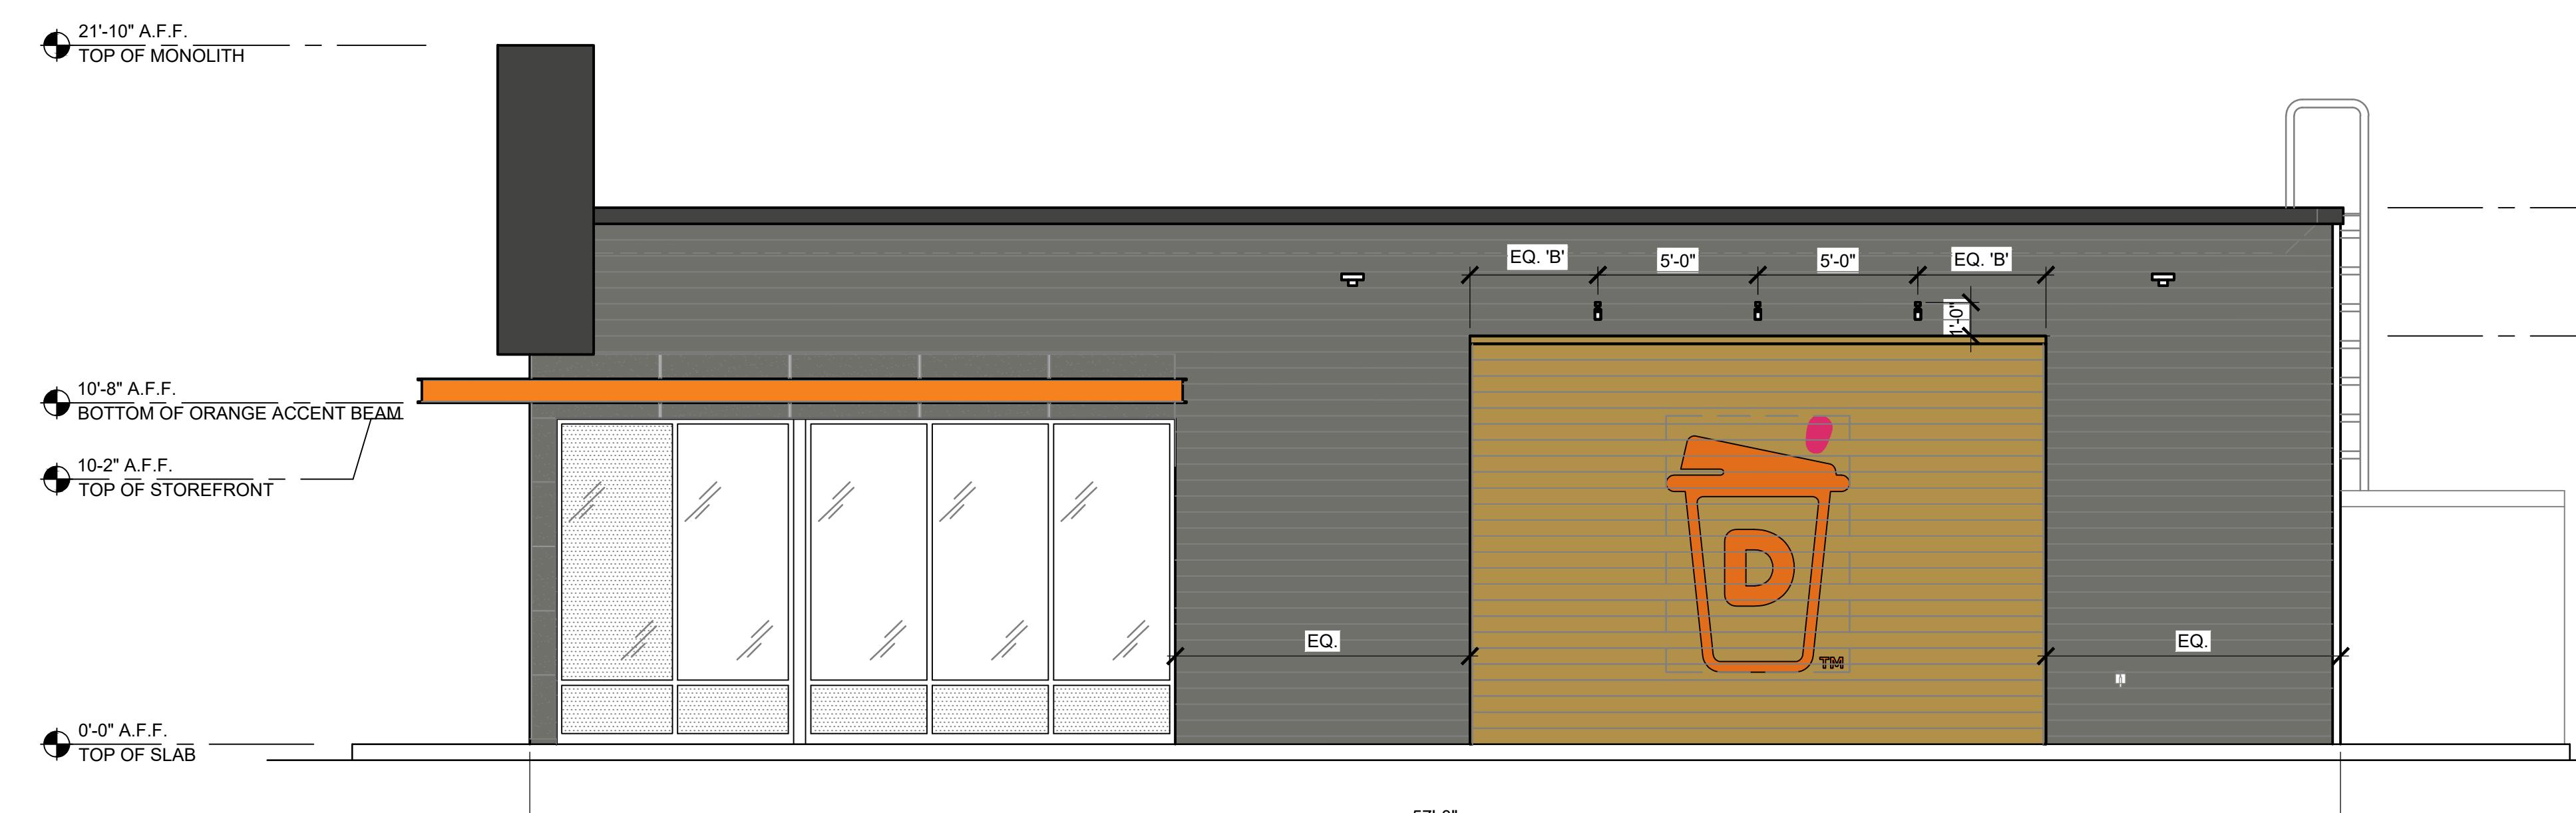NOTE: DRAWINGS ARE NOT TO SCALE IF SHEET IS PLOTTED ON 11" x 17"

